CITY OF GREENVILLE WAYFINDING AND SIGNAGE PROGRAM CONSTRUCTION DOCUMENTATION PACKAGE

May 22, 2010

City of Greenville Greenville, NC

Project No. 41-07984.000



120 North Church Street
Suite 208
West Chester, PA 19380
T 484.266.0648
www.merjedesign.com

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SECTION 1 | Signage Drawings

A. Graphic Standards

PRIMARY TYPEFACE

Clearview Highway ABCDEFGHIJKLMNOPQRSTUVWXYZ abcdefghijklmnopqrstuvwxyz 1234567890 ''!@#\$%^

Amongst the several mechanical Arts that have engaged my attention, there is no one which I have pursued with so much steadiness and pleasure, as that of Letter Founding.

Library Library Library NOT acceptable NOT acceptable

123A 123A 123A NOT acceptable NOT acceptable

SPECIFICATIONS

The Contractor must submit a full alphabet of 1" letters and numerals.

All type shall be set exactly as specified. Substitutions will only be accepted, at the Client's or Designer's discretion, where they match the specified typeface in every detail. The Contractor shall be aware that different versions of typesetting equipment may not satisfactorily match specified type faces and in such instances will not be acceptable.

Sometimes the Foot mark is mistaken for an apostrophe and an inch mark is mistaken for quotations. Below are examples of correct and incorrect apostrophe's for each typeface.

CLEARVIEW HWY 2-W



This apostrophe is CORRECT.

PARK'S



DESIGN NOTE:

Final design and shop drawings shall be supplied by the fabricator. North Carolina registered professional engineer is required to sign and seal the submittal of shop drawings.

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merje	120 North Church Street Suite 208 West Chester, PA 19380 T 484.266.0648 www.merjedesign.com	Clty of Greenville, NC City of Greenville, NC Wayfinding and Signage
		PROJECT NO. Y41-07963
UBCONSULTANT		SHEET TITLE
ATE 6/30/2009	DRAWN BY: KB	Typography
ese drawings are meant for DESIGN INTENT ONLY dare not for construction. Contractor shall verify	REVISIONS	Specifications
d be responsible for all dimensions and conditions the job. Contractor shall be familiar with the site d conditions it presents. This office must be noti-	5/22/2010	
d of any variations from the dimensions and condi- ns shown on this drawing. Shop drawings and		SHEET NO.
tails must be submitted to this office for approval for to proceeding with fabrication. All copy shall be oofread by client and legal requirements checked legal department.		A.1

SECONDARY TYPEFACE

Rawlinson Regular ABCDEFGHIJKLMNOPQRSTUVWXYZ abcdefghijklmnopqrstuvwxyz 1234567890 ''!@#\$%^

Amongst the several mechanical Arts that have engaged my attention, there is no one which I have pursued with so much steadiness and pleasure, as that of Letter Founding.

Library	Library	Library
acceptable	NOT acceptable	NOT acceptable
1021	102 /	1 2 2 1
123A	123A	123A
acceptable	NOT acceptable	NOT acceptable

SPECIFICATIONS

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All type shall be set exactly as specified. Substitutions will only be accepted, at the Client's discretion, where they match the specified typeface in every detail. The Contractor shall be aware that different versions of typesetting equipment may not satisfactorily match specified type faces and in such instances will not be acceptable.

Sometimes the Foot mark is mistaken for an apostrophe and an inch mark is mistaken for quotations. Below are examples of correct and incorrect apostrophe's for each typeface.

RAWLINSON REGULAR



This apostrophe is CORRECT.

PARK'S



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NOTE

EXPERIENCES	CLIENT / PROJECT
120 North Church Street Suite 208 West Chester, PA 19380 T 484.266.0648	Clty of Greenville, NC City of Greenville, NC Wayfinding and Signage
www.merjedesign.com	PROJECT NO. Y41-07963
	SHEET TITLE
DRAWN BY: KB	Typography
REVISIONS	Specifications
5/22/2010	
	SHEET NO.
	A.2
	120 North Church Street Suite 208 West Chester, PA 19380 T 484.266.0648 www.merjedesign.com DRAWN BY: KB REVISIONS

LETTER SPACING

Inconsistencies in Letter Spacing

Corrected Letter Spacing

TYPEFACE 1

TYPEFACE 1

Greenville

Greenville

IMPORTANT: Individual spacing of each letter needs to be evaluated. See Examples Above.

Kern all Copy so that each character is optically centered between the center of each of the surrounding characters.

ARROWS AND TEXT RELATIONSHIPS

Always measure from baselline to baseline. Please Reference to the arrow detail below.



COPY HEIGHT

When measuring copy height, measure only the height of the Capital letters to determine your overall copy height shown in illustration below as "X." Some of the other letters have an extended height beyond the average height of the letters.



LINE SPACING

When measuring line spacing, always measure from the baseline of the top most text line to the baseline of the text line below shown as "X."



SPECIFICATIONS

ALL TYPE SHALL BE SET EXACTLY AS SPECIFIED.

Individual spacing of each letter shall be evaluated and approved by the DESIGNER and CLIENT prior to sign fabrication. All copy shall be kerned so that each character is optically centered between the center of each of the surrounding characters.

DESIGN NOT

Final design and shop drawings shall be supplied by the fabricator. North Carolina registered professional engineer is required to sign and seal the submittal of shop drawings.

NOTES

CLIENT / PROJECT ENVIRONMENTS & EXPERIENCES Clty of Greenville, NC 120 North Church Street City of Greenville, NC Suite 208 Wayfinding and Signage West Chester, PA 19380 T 484.266.0648 www.merjedesign.com PROJECT NO. Y41-07963 SUBCONSULTANT SHEET TITLE DRAWN BY: ΚB 6/30/2009 Typography REVISIONS These drawings are meant for DESIGN INTENT ONLY Specifications and are not for construction. Contractor shall verify and be responsible for all dimensions and conditiof the job. Contractor shall be familiar with the site 5/22/2010 and conditions it presents. This office must be noti-SHEET NO. fied of any variations from the dimensions and cond tions shown on this drawing. Shop drawings and details must be submitted to this office for approval **A.3** prior to proceeding with fabrication. All copy shall be proofread by client and legal requirements checked by legal departmen

Districts

Uptown District

Medical District

Convention District

Education

ECU

ECU Main Campus

ECU Stadiums

P.C.C. Main Campus

P.C.C. Greenville Ctr.

Rose High School Government

City Hall Courthouses County Admin. Office

Historic & Tourism

Chamber of Commerce

Convention Center

Visitor Center NAACP

Transportation

Airport

...

Arts & Cultural

Museum of Art

* Ampitheater

G.W. Carver Branch Library

East Branch Library

Sheppard Mem. Library

Five Points Plaza

Parking

Public Parking
City Hall
Parking

Other

Industrial Park

Hospitals

Hospital

Parks & Recreation

Science and Nature Center

Town Common

Thomas Foreman Park

- * Green Springs Park
- * Elm St. Park
- * Jaycee Park
- * Peppermint Park
- * Evans Park
- * Boyd Lee Park

City

Tarboro

SPECIFICATIONS

Terminology Shown represents Graphic Breaks for Vehicular Directional Signs with 4" High Copy.

ALL TYPE SHALL BE SET EXACTLY AS SPECIFIED.

DESIGN NOTE

Final design and shop drawings shall be supplied by the fabricator. North Carolina registered professional engineer is required to sign and seal the submittal of shop drawings.

NOTES

SUBCONSULTANT

ENVIRONMENTS & EXPERIENCES

120 North Church Street

merje

6/30/2009

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KΒ

City of Greenville, NC Wayfinding and Signage

Clty of Greenville, NC

PROJECT NO. Y41-07963

CLIENT / PROJECT

SHEET TITLE

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Word Breaks

SHEET NO.

A.4

* Potential Future - Vehicular Destinations



Leaf Symbol



Uptown Logo

Convention District Logo

Medical District Logo

ARROWS



Left Arrow



Up-Left Arrow



Straight Arrow



Up-Right Arrow



Right Arrow



Straight-Left Arrow

Up-Straight-Left Arrow



Up-Straight-Right Arrow

Straight-Right Arrow

SPECIFICATIONS

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USE of Arrows

When multiple directions are required on a sign, the following directional hierarchy shall take precedent. See Example below. Reference Message Schedule for individual Messages.



Straight Arrow



Left Arrow



Right Arrow

DESIGN NOTE:

Final design and shop drawings shall be supplied by the fabricator. North Carolina registered professional engineer is required to sign and seal the submittal of shop drawings.

NOTES

SUBCONSULTANT

by legal department

Suite 208

ENVIRONMENTS & EXPERIENCES

120 North Church Street West Chester, PA 19380 T 484.266.0648

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KB

DRAWN BY:

5/22/2010

CIty of Greenville, NC

City of Greenville, NC

Wayfinding and Signage

PROJECT NO. Y41-07963 SHEET TITLE

SHEET NO.

CLIENT / PROJECT

REVISIONS These drawings are meant for DESIGN INTENT ONLY and are not for construction. Contractor shall verify and be responsible for all dimensions and condition of the job. Contractor shall be familiar with the site and conditions it presents. This office must be notified of any variations from the dimensions and cond tions shown on this drawing. Shop drawings and details must be submitted to this office for approval prior to proceeding with fabrication, All copy shall be

6/30/2009

proofread by client and legal requirements checked

Project Artwork

A.5

P PAINTS	NAME	SPECIFICATION	PROCESS	SPECIFICATIONS	
P1	Dark Blue	Paint to match	Surface painted, plus Polyurethane UV Clear Coat Protectant	The Contractor shall submit 2 identical sets of each color specified for approval to the client prior to any painting. Sample swatches are to be produced on the sub-	
P2	Dark Green		Surface painted, plus Polyurethane UV Clear Coat Protectant	strate material of the final product. The colors must look exactly the same every time they are used so that people	
Р3	Light Green		Surface painted, plus Polyurethane UV Clear Coat Protectant	associate them with the City of Greenville, NC. All media, vinyl, paint, and inks must be produced so that the colors match as	
P4	Dark Red	D : 4000	Surface painted, plus Polyurethane UV Clear Coat Protectant	specified on this page.	
P5	Silver	"B ! ! A! ' "	Surface painted, plus Polyurethane UV Clear Coat Protectant		
P6	Bronze		Surface painted, plus Polyurethane UV Clear Coat Protectant		
P7	Black		Surface painted, plus Polyurethane UV Clear Coat Protectant		
P8	Gray		Surface painted, plus Polyurethane UV Clear Coat Protectant		
P9	White		Surface painted, plus Polyurethane UV Clear Coat Protectant		
P10	Light Blue		Surface painted, plus Polyurethane UV Clear Coat Protectant		
V VINYLS					
V1	Dark Blue Reflective	3M High Intensity Prismatic Reflective Sheeting 3 Color Match: Pantone 654C	Custom Digital Print with UV /Graffiti Gloss Coating Drop Out White Lettering		DESIGN NOTE: Final design and shop drawings shall be supplied by the fabricator. North Carolina registered professional
V2	Dark Green Reflective	3M High Intensity Prismatic Reflective Sheeting 3 Color Match: Pantone 554C	Custom Digital Print with UV /Graffiti Gloss Coating Drop Out White Lettering		engineer is required to sign and seal the submittal of shop drawings.
V3	Light Blue Reflective	3M High Intensity Prismatic Reflective Sheeting 3 Color Match: Pantone 314C	Surface Custom Digital Print with UV / Graffiti Gloss Coating Drop Out White Lettering	NOTES	
V4	Silver	3M Opaque Vinyl 3M 180C-220 "Light Silver Metallic"	Surface Applied		
V5	White Reflective	3M High Intensity Prismatic Reflective Sheeting Color: 3930 "White"	Custom Digital Print with UV /Graffiti Gloss Coating Drop Out White Lettering	ENVIRONMENTS & EXPERIENCES 120 North Church Street	CLIENT / PROJECT City of Greenville, NC
V6	White	3M Opaque Vinyl Color: 180C-10 "White"	Surface Applied	Suite 208 West Chester, PA 19380 T 484.266.0648	City of Greenville, NC Wayfinding and Signage
V7	Light Green	3M Opaque Vinyl Color Match: Pantone 376C	Surface Applied	www.merjedesign.com SUBCONSULTANT	PROJECT NO. Y41-07963 SHEET TITLE
V8	DOT Green Reflective	3M High Intensity Prismatic Reflective Sheeting Color: 3937	DOT COLOR with Surface applied lettering	DATE 6/30/2009 DRAWN BY: KB These drawings are meant for DESIGN INTENT ONLY and are not for construction. Contractor shall verify	Color Chart
V9	DOT Blue Reflective	3M High Intensity Prismatic Reflective Sheeting Color: 3935	DOT COLOR with Surface applied lettering	and be responsible for all dimensions and conditions of the job. Contractor shall be familiar with the site and conditions it presents. This office must be notified of any variations from the dimensions and conditions shown on this drawing. Shop drawings and	SHEET NO.
V10	Gray	3M Opaque Vinyl Color: 180C-31 "Medium Gray"	Surface Applied	details must be submitted to this office for approval prior to proceeding with fabrication. All copy shall be proofread by client and legal requirements checked by legal department.	A.6

B. Menu of Sign Types





Scale: 1/4" = 1'-0"

Founded 1774

GATE.1 GATE.2



SPECIFICATIONS

City Gateway GATE.1 GATE.2

District Gateway

DIST_GATE.1A DIST_GATE.1B DIST_GATE.1C DIST_GATE.2A


DIST_GATE.2B DIST_GATE.2C


DESIGN NOTE:

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Sign Types shown on this page represent the entire wayfinding system. Not all sign types may be built concurrently and may be bid in phases, please reference the sign location plan/message schedule and bid form for quantities.

ENVIRONMENTS &	EXPERIENCES	CLIENT / PROJECT
merje	120 North Church Street Suite 208 West Chester, PA 19380 T 484.266.0648	Clty of Greenville, NC City of Greenville, NC Wayfinding and Signage
	www.merjedesign.com	PROJECT NO. Y41-07963
SUBCONSULTANT		SHEET TITLE
DATE 6/30/2009	DRAWN BY: KB	Sign Menu
These drawings are meant for DESIGN INTENT ONLY and are not for construction. Contractor shall verify	REVISIONS	Gateways
and be responsible for all dimensions and conditions of the job. Contractor shall be familiar with the site and conditions it presents. This office must be noti-	5/22/2010	
fied of any variations from the dimensions and conditions shown on this drawing. Shop drawings and		SHEET NO.
details must be submitted to this office for approval prior to proceeding with fabrication. All copy shall be proofread by client and legal requirements checked		B.1
by legal department.		



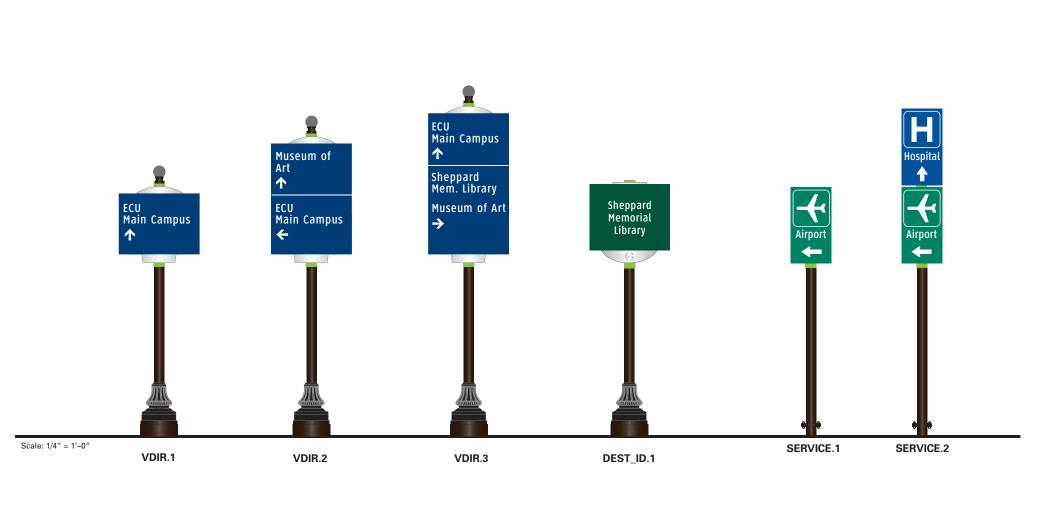

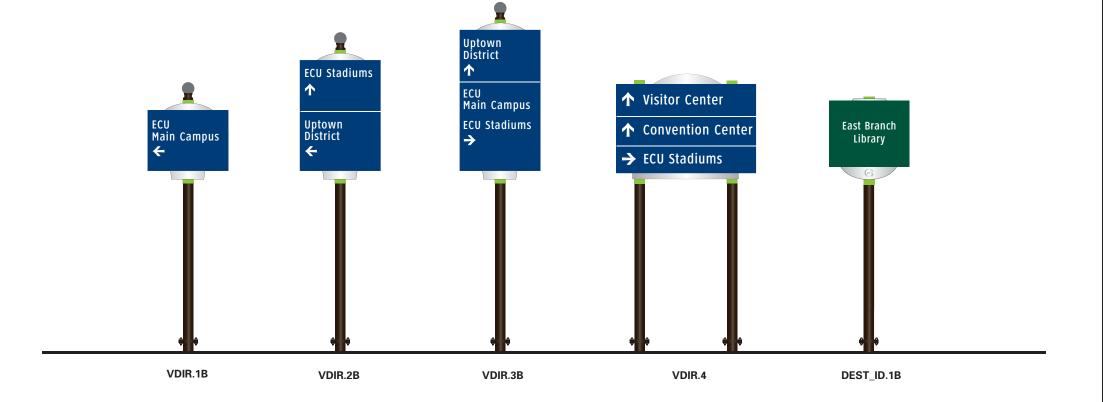SPECIFICATIONS

Destination Arrival

DEST_ID.1 DEST_ID.1B

Service Trailblazers

SERVICE.1 SERVICE.2

Vehicular Directional - Uptown

VDIR.1 VDIR.2 VDIR.3

Vehicular Directional

VDIR.1B VDIR.2B VDIR.3B VDIR.4


DESIGN NOTE:


Final design and shop drawings shall be supplied by the fabricator. North Carolina registered professional engineer is required to sign and seal the submittal of shop drawings.

NOTE

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	www.merjedesign.com	PROJECT NO. Y41-07963
UBCONSULTANT	SHEET TITLE	
ATE 6/30/2009	DRAWN BY: KB	Sign Menu
nese drawings are meant for DESIGN INTENT ONLY nd are not for construction. Contractor shall verify	REVISIONS	Directionals
nd be responsible for all dimensions and conditions if the job. Contractor shall be familiar with the site and conditions it presents. This office must be noti-	5/22/2010	
ed of any variations from the dimensions and condi- ons shown on this drawing. Shop drawings and		SHEET NO.
etails must be submitted to this office for approval ior to proceeding with fabrication. All copy shall be roofread by client and legal requirements checked y legal department.		B.2



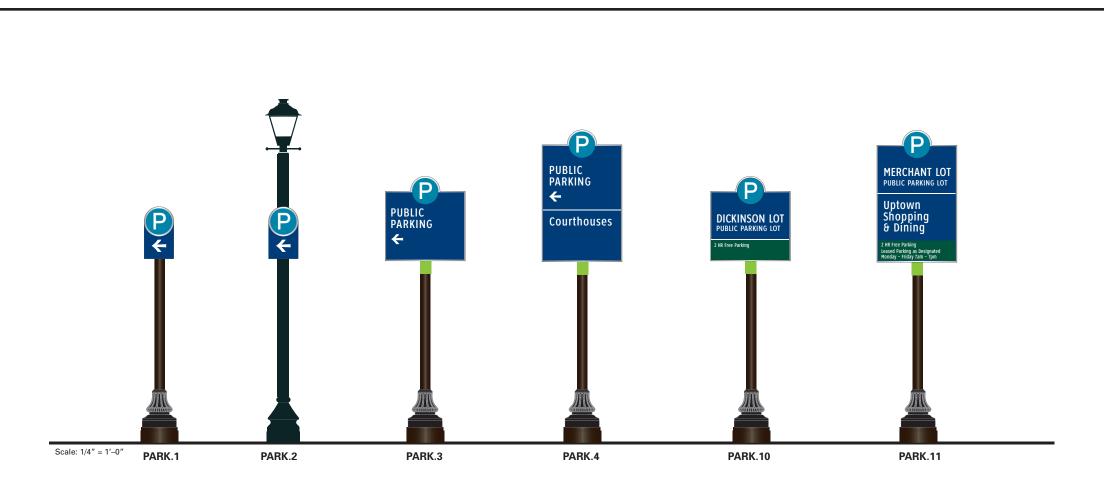

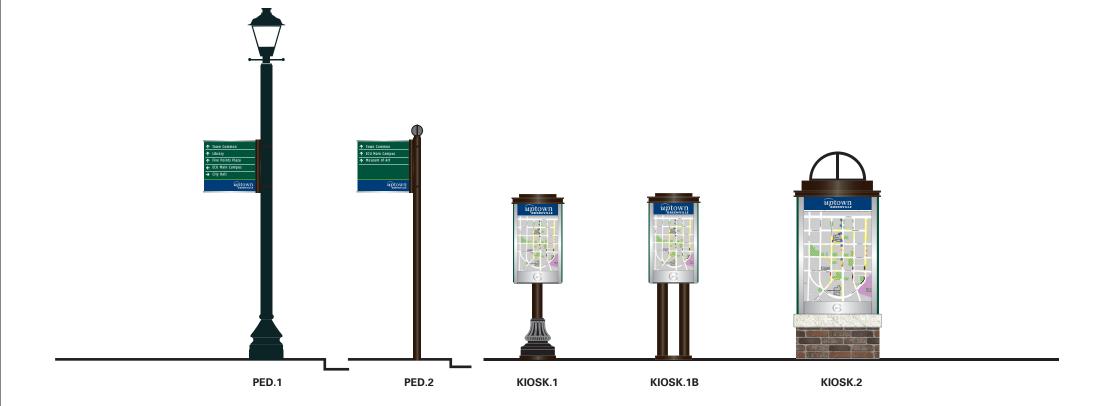SPECIFICATIONS

Parking Directionals

PARK.1

PARK.2 PARK.3

PARK.4

Parking Identification

PARK.10 PARK.11

Pedestrian Directionals

PED.2

Pedestrian Kiosks

KIOSK.1

KIOSK.1B

KIOSK.2

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ENVIRONMENTS & EXPERIENCES

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CLIENT / PROJECT

Clty of Greenville, NC City of Greenville, NC Wayfinding and Signage

PROJECT NO. Y41-07963

SUBCONSULTANT SHEET TITLE DRAWN BY: 6/30/2009 KΒ Sign Menu REVISIONS These drawings are meant for DESIGN INTENT ONLY Parking & Pedestrian and are not for construction. Contractor shall verify and be responsible for all dimensions and conditions of the job. Contractor shall be familiar with the site 5/22/2010 and conditions it presents. This office must be noti-SHEET NO. fied of any variations from the dimensions and condi tions shown on this drawing. Shop drawings and details must be submitted to this office for approval B.3 prior to proceeding with fabrication. All copy shall be proofread by client and legal requirements checked

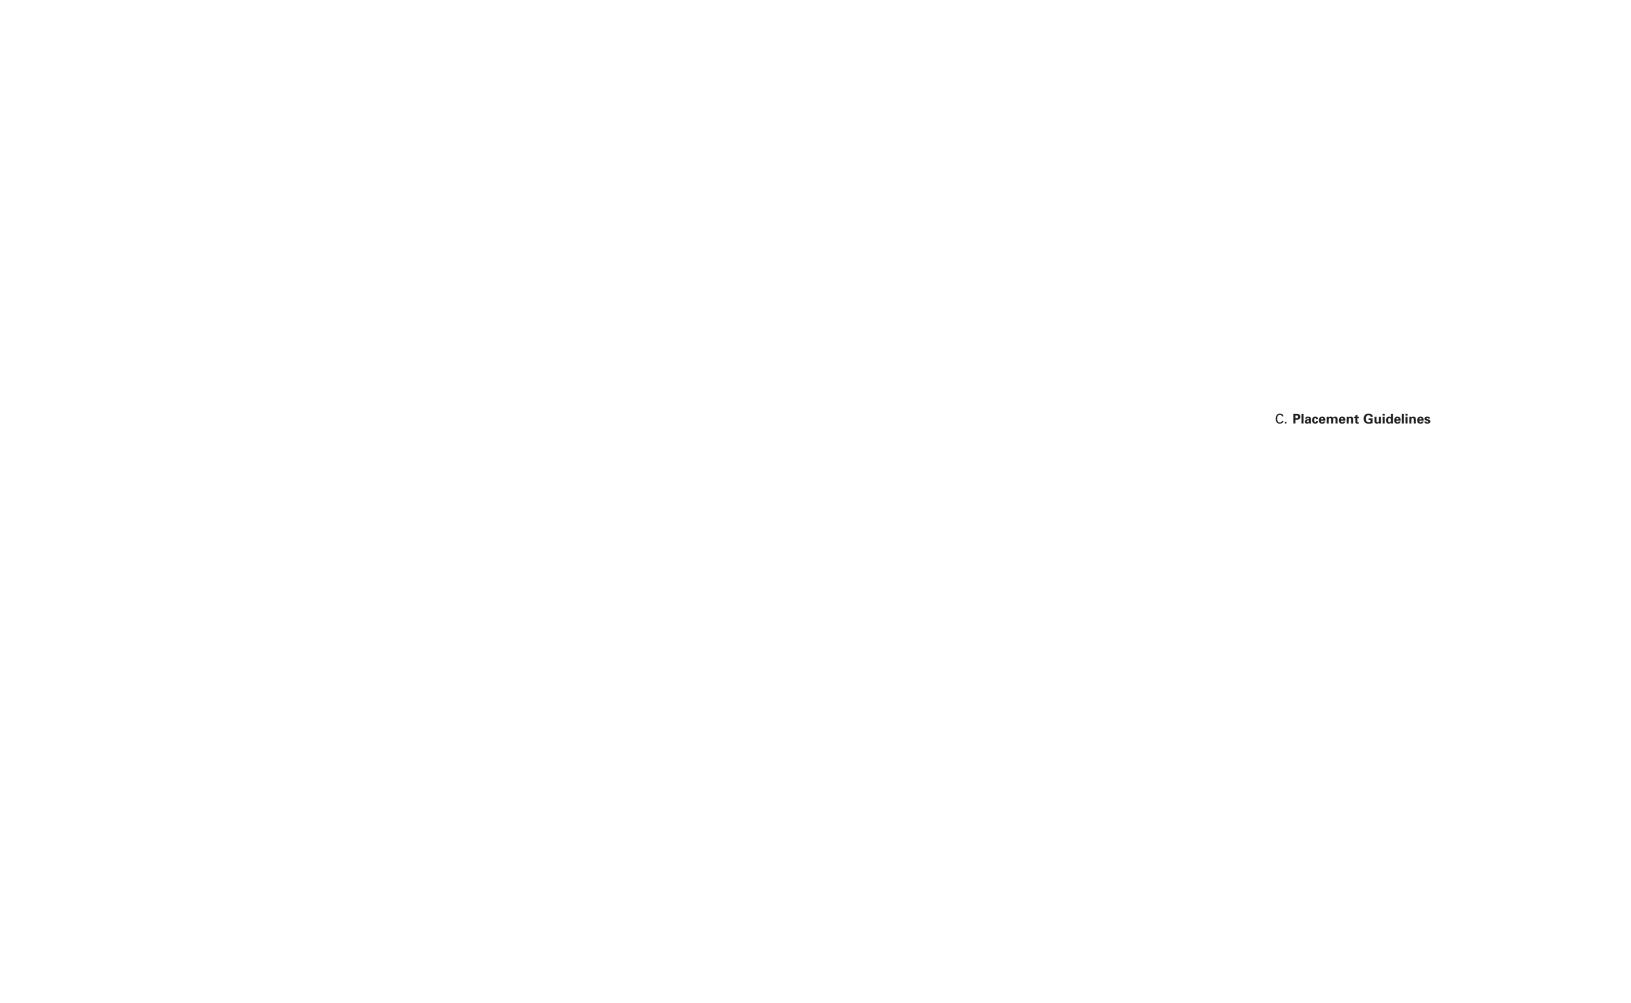


Figure 1

Sign A: VDIR.1-VDIR.4, SERVICE.1-SERVICE.2


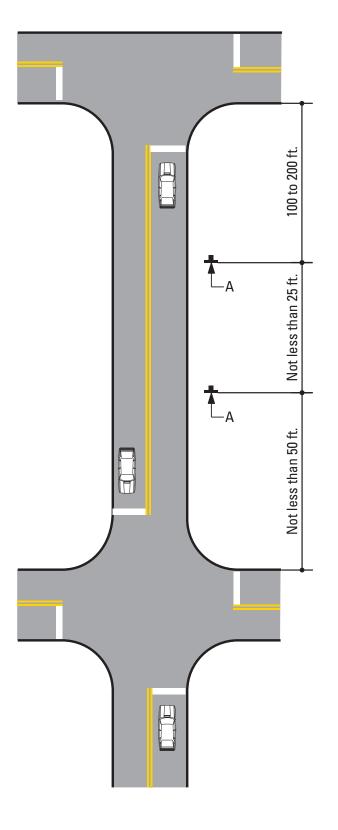


Figure 2

Sign C: PARK.1-PARK.4 Sign D: PARK.10-PARK.11

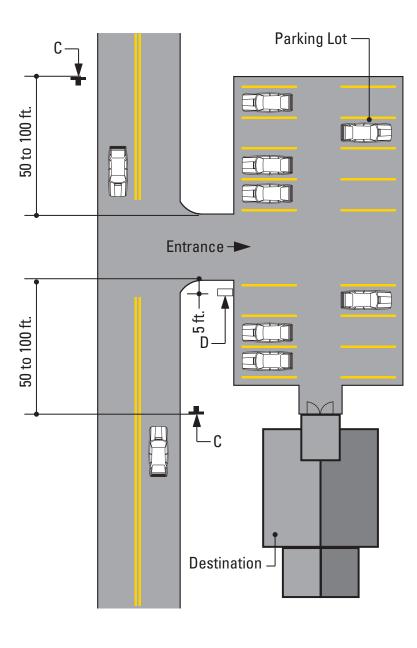

SPECIFICATIONS

FIGURE 1- Vehicular Directuional - Sign Placement Guideline FIGURE 2 - Parking - Sign Placement Guideline

Unless approved by the Client or its designated agent, all signs shall be installed to the right of the direction of traffic and where sufficient space is available.

- (a) Signs shall be located to take advantage of natural terrain, to minimize impacts on scenic environment and to avoid visual conflicts with other signs, trees and lampposts within the City right-of-way.
- (b) Signs shall be located so as not to interfere with, obstruct or divert driver's attention from any other Official Traffic Control Device. Other Official Traffic Control Devices placed at intersection approaches, subsequent to the placement of a Wayfinding Sign, shall have precedence as to location and may require the relocation of the Wayfinding Sign. In the locations where Official Traffic Control Devices are integrated into the Wayfinding Signage System, the Official Traffic Control Devices shall take precedence with regard to order, space and location, over other information.
- (c) Wayfinding Signs shall be positioned in such a manner that does not restrict driver's attention or view when making turns or driving through an intersection.
- (d) There shall be a goal of one sign per block, although two are permissible, where necessary.

The following pages illustrate installation guidelines for the location and spacing of the various sign types. Figures 1 through 6 represent the guidelines for the location of the various sign types, while Figure 7 illustrates the lateral clearance guidelines.

DESIGN NOTE:

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	www.merjedesign.com	PROJECT NO. Y41-07963
SUBCONSULTANT	SHEET TITLE	
DATE 6/30/2009	DRAWN BY: KB	Sign Placement
These drawings are meant for DESIGN INTENT ONLY and are not for construction. Contractor shall verify	REVISIONS	Guidelines
and be responsible for all dimensions and conditions of the job. Contractor shall be familiar with the site and conditions it presents. This office must be noti-	5/22/2010	
fied of any variations from the dimensions and conditions shown on this drawing. Shop drawings and		SHEET NO.
details must be submitted to this office for approval prior to proceeding with fabrication. All copy shall be proofread by client and legal requirements checked by legal department.		C.1

Figure 3

Sign E: DESTID.1-DESTID.1b


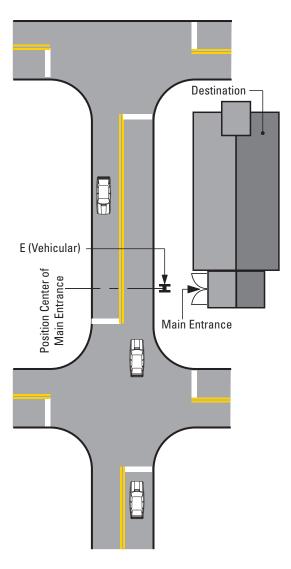


Figure 4

Sign A: VDIR.1-VDIR.4, SERVICE.1-SERVICE.2

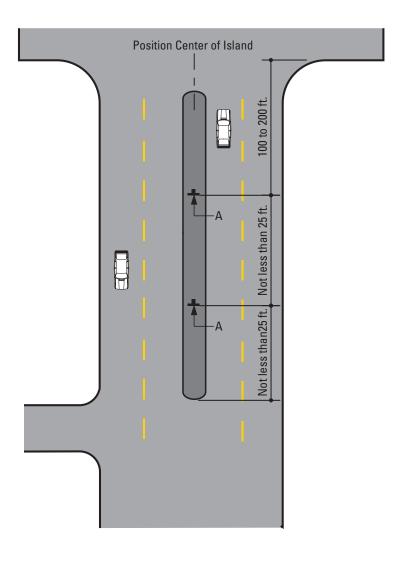

SPECIFICATIONS

FIGURE 3- Destination Arrival-Vehicular/Pedestrian - Sign Placement Guideline FIGURE 4 - Vehicular Directuional - Sign Placement Guideline

Unless approved by the Client or its designated agent, all signs shall be installed to the right of the direction of traffic and where sufficient space is available.

- (a) Signs shall be located to take advantage of natural terrain, to minimize impacts on scenic environment and to avoid visual conflicts with other signs, trees and lampposts within the City right-of-way.
- (b) Signs shall be located so as not to interfere with, obstruct or divert driver's attention from any other Official Traffic Control Device. Other Official Traffic Control Devices placed at intersection approaches, subsequent to the placement of a Wayfinding Sign, shall have precedence as to location and may require the relocation of the Wayfinding Sign. In the locations where Official Traffic Control Devices are integrated into the Wayfinding Signage System, the Official Traffic Control Devices shall take precedence with regard to order, space and location, over other information.
- (c) Wayfinding Signs shall be positioned in such a manner that does not restrict driver's attention or view when making turns or driving through an intersection.
- (d) There shall be a goal of one sign per block, although two are permissible, where necessary.

The following pages illustrate installation guidelines for the location and spacing of the various sign types. Figures 1 through 6 represent the guidelines for the location of the various sign types, while Figure 7 illustrates the lateral clearance guidelines.

DESIGN NOTE:

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merje	120 North Church Street Suite 208 West Chester, PA 19380 T 484.266.0648	Clty of Greenville, NC City of Greenville, NC Wayfinding and Signage
	www.merjedesign.com	PROJECT NO. Y41-07963
SUBCONSULTANT		SHEET TITLE
DATE 6/30/2009	DRAWN BY: KB	Sign Placement
These drawings are meant for DESIGN INTENT ONLY and are not for construction. Contractor shall verify	REVISIONS	Guidelines
and be responsible for all dimensions and conditions of the job. Contractor shall be familiar with the site and conditions it presents. This office must be noti-	5/22/2010	
fied of any variations from the dimensions and condi- tions shown on this drawing. Shop drawings and		SHEET NO.
details must be submitted to this office for approval prior to proceeding with fabrication. All copy shall be proofread by client and legal requirements checked by legal department.		C.2

Figure 5

Sign E: GATE.2a to GATE.2c


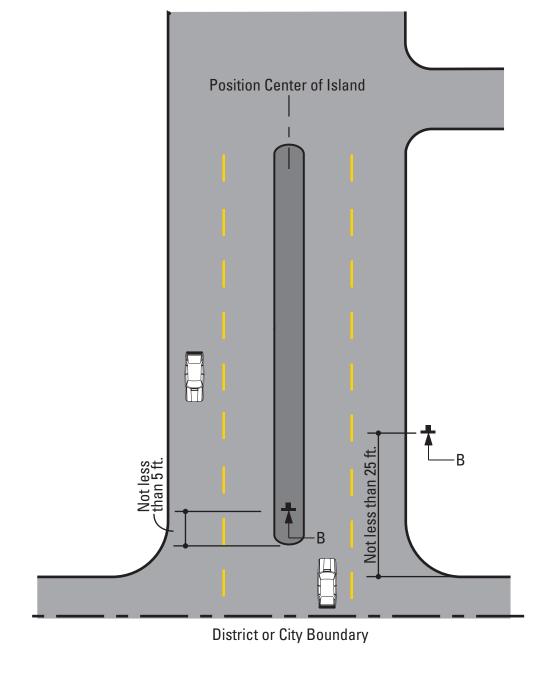


Figure 6

Sign A: VDIR.1 to VDIR.4, SERVICE.1-SERVICE.2

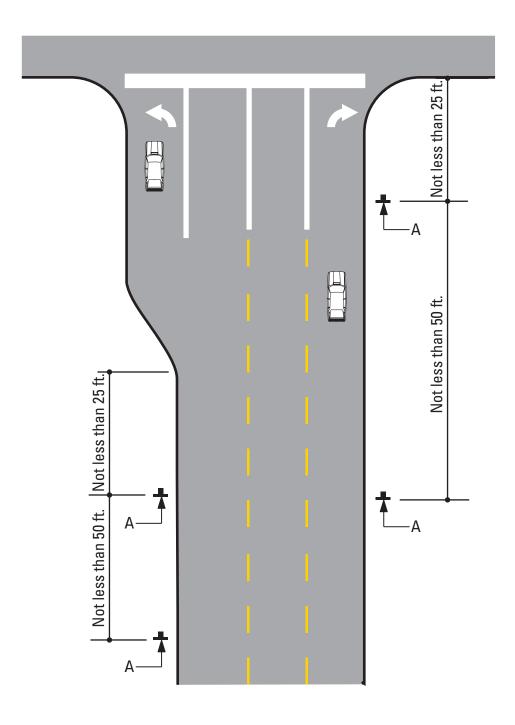

SPECIFICATIONS

FIGURE 5- Gateway/District Arrival-Vehicular - Sign Placement Guideline FIGURE 6 - Vehicular Directional - Sign Placement Guideline

Unless approved by the Client or its designated agent, all signs shall be installed to the right of the direction of traffic and where sufficient space is available.


- (a) Signs shall be located to take advantage of natural terrain, to minimize impacts on scenic environment and to avoid visual conflicts with other signs, trees and lampposts within the City right-of-way.
- (b) Signs shall be located so as not to interfere with, obstruct or divert driver's attention from any other Official Traffic Control Device. Other Official Traffic Control Devices placed at intersection approaches, subsequent to the placement of a Wayfinding Sign, shall have precedence as to location and may require the relocation of the Wayfinding Sign. In the locations where Official Traffic Control Devices are integrated into the Wayfinding Signage System, the Official Traffic Control Devices shall take precedence with regard to order, space and location, over other information.
- (c) Wayfinding Signs shall be positioned in such a manner that does not restrict driver's attention or view when making turns or driving through an intersection.
- (d) There shall be a goal of one sign per block, although two are permissible, where necessary.

The following pages illustrate installation guidelines for the location and spacing of the various sign types. Figures 1 through 6 represent the guidelines for the location of the various sign types, while Figure 7 illustrates the lateral clearance guidelines.

DESIGN NOTE:

Final design and shop drawings shall be supplied by the fabricator. North Carolina registered professional engineer is required to sign and seal the submittal of shop drawings.

ENVIRONMENTS &	EXPERIENCES	CLIENT / PROJECT
merje	120 North Church Street Suite 208 West Chester, PA 19380 T 484.266.0648	Clty of Greenville, NC City of Greenville, NC Wayfinding and Signage
	www.merjedesign.com	PROJECT NO. Y41-07963
SUBCONSULTANT		SHEET TITLE
DATE 6/30/2009	DRAWN BY: KB	Sign Placement
These drawings are meant for DESIGN INTENT ONLY and are not for construction. Contractor shall verify	REVISIONS	Guidelines
and be responsible for all dimensions and conditions of the job. Contractor shall be familiar with the site and conditions it presents. This office must be noti-	5/22/2010	
fied of any variations from the dimensions and condi- tions shown on this drawing. Shop drawings and		SHEET NO.
details must be submitted to this office for approval prior to proceeding with fabrication. All copy shall be proofread by client and legal requirements checked by legal department.		C.3

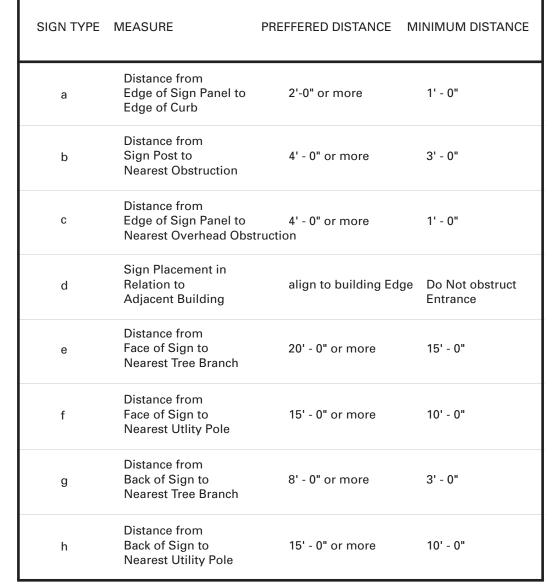

Measurements and Distances shown are guidelines only prevailing local and state codes shall supersede information presented.

		DESIGN NOTE: Final design and shop drawings shall be supplied by the fabricator. North Carolina registered professional engineer is required to sign and seal the submittal of shop drawings.
NOTES		
ENVIRONMENTS &	EXPERIENCES	CLIENT / PROJECT
merje	120 North Church Street Suite 208 West Chester, PA 19380 T 484.266.0648	Clty of Greenville, NC City of Greenville, NC Wayfinding and Signage
	www.merjedesign.com	PROJECT NO. Y41-07963

DRAWN BY:

REVISIONS

5/22/2010

KΒ

C.4

Sign Placement

Guidelines

SHEET TITLE

SHEET NO.

SPECIFICATIONS

SUBCONSULTANT

by legal department.

6/30/2009


These drawings are meant for DESIGN INTENT ONLY and are not for construction. Contractor shall verify

and be responsible for all dimensions and conditions of the job. Contractor shall be familiar with the site

and conditions it presents. This office must be noti-fied of any variations from the dimensions and condi-tions shown on this drawing. Shop drawings and

details must be submitted to this office for approval

prior to proceeding with fabrication. All copy shall be proofread by client and legal requirements checked

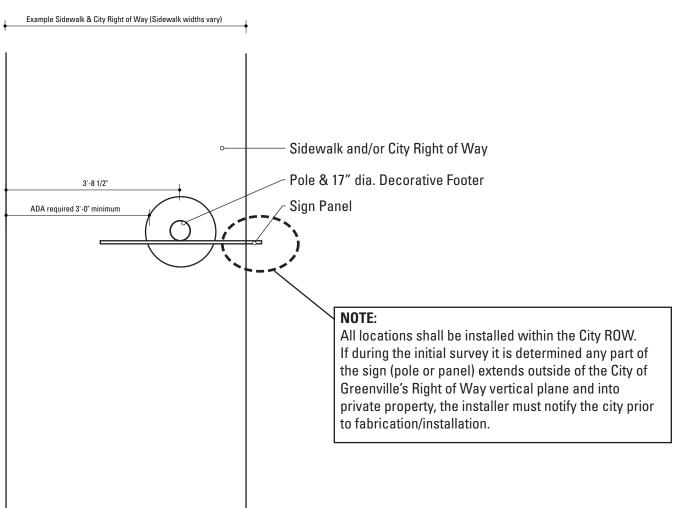

SIGN T	VDE E	DISTANCE EDGE OF CURB to EDGE OF SIGN FANEL	DISTANCE TO CENTER OF POST
DEST	_ID.1-1B	2'-0"	3'-8"
DEST	_ID.1-1B	1'-6"	3'-2"
DEST	_ID.1-1B	1'-0"	2'-8"
DIST_	GATE.1-2A-B	2'-0"	5'-2 1/2"
DIST_	GATE.1-2A-B	1'-6"	4'-8 1/2"
DIST_	GATE.1-2A-B	1'-0"	4'-2 1/2"
DIST_	GATE.1-2C	2'-0"	5'-8 1/2"
DIST_	GATE.1-2C	1'-6"	5'-2 1/2"
DIST_	GATE.1-2C	1'-0"	4'-8 1/2"
GATE.	2	2'-0"	5'-1 3/8"
GATE.	2	1'-6"	4'-7 3/8"
GATE.	2	1'-0"	4'-1 3/8"
PARK.	1	2'-0"	2'-7 1/2"
PARK.	1	1'-6"	2'-1 1/2"
PARK.	1	1'-0"	1'-7 1/2"
PARK.	3-4	2'-0"	3'-8"
PARK.	3-4	1'-6"	3'-2"
PARK.	3-4	1'-0"	2'-8"
PARK.	10-11	2'-0"	3'-8"
PARK.	10-11	1'-6"	3'-2"
PARK.	10-11	1'-0"	2'-8"
SERVI	CE.1-2	2'-0"	2'-9 3/4"
SERVI	CE.1-2	1'-6"	2'-3 3/4"
SERVI	CE.1-2	1'-0"	1'-9 3/4"
VDIR.1		2'-0"	3'-8"
VDIR.1		1'-6"	3'-2"
VDIR.1		1'-0"	2'-8"
VDIR.1	1B-3B	2'-0"	3'-8"
VDIR.1		1'-6"	3'-2"
VDIR.1	1B-3B	1'-0"	2'-8"

Final design and shop drawings shall be supplied by the fabricator. North Carolina registered professional engineer is required to sign and seal the submittal of shop drawings.


SPECIFICATIONS


- 1. Fabricator shall verify the mounting conditions and provide a detail drawing for each mounting situation, prior to fabrication. Fabricator shall obtain approval from the Designer or Client for placement prior to fabri-
- 2. Welds: All welds shall be ground smooth, paint all seams.


ENVIRONMENTS &	EXPERIENCES	CLIENT / PROJECT
merje	120 North Church Street Suite 208 West Chester, PA 19380 T 484.266.0648	CIty of Greenville, NC City of Greenville, NC Wayfinding and Signage
	www.merjedesign.com	PROJECT NO. Y41-07963
SUBCONSULTANT		SHEET TITLE
OATE 6/30/2009	DRAWN BY: KB	Sian Placement
6/30/2009 hese drawings are meant for DESIGN INTENT ONLY are not for construction. Contractor shall verify	DRAWN BY: KB REVISIONS	Sign Placement Guidelines
6/30/2009 hese drawings are meant for DESIGN INTENT ONLY and are not for construction. Contractor shall verify and be responsible for all dimensions and conditions the job. Contractor shall be familiar with the site	KB	-
6/30/2009 hese drawings are meant for DESIGN INTENT ONLY	REVISIONS KB	-


Reference View: Example - 5 foot Sidewalk / City Right of Way SCALE: 1/2" = 1'-0"

D. Design Intent Drawings

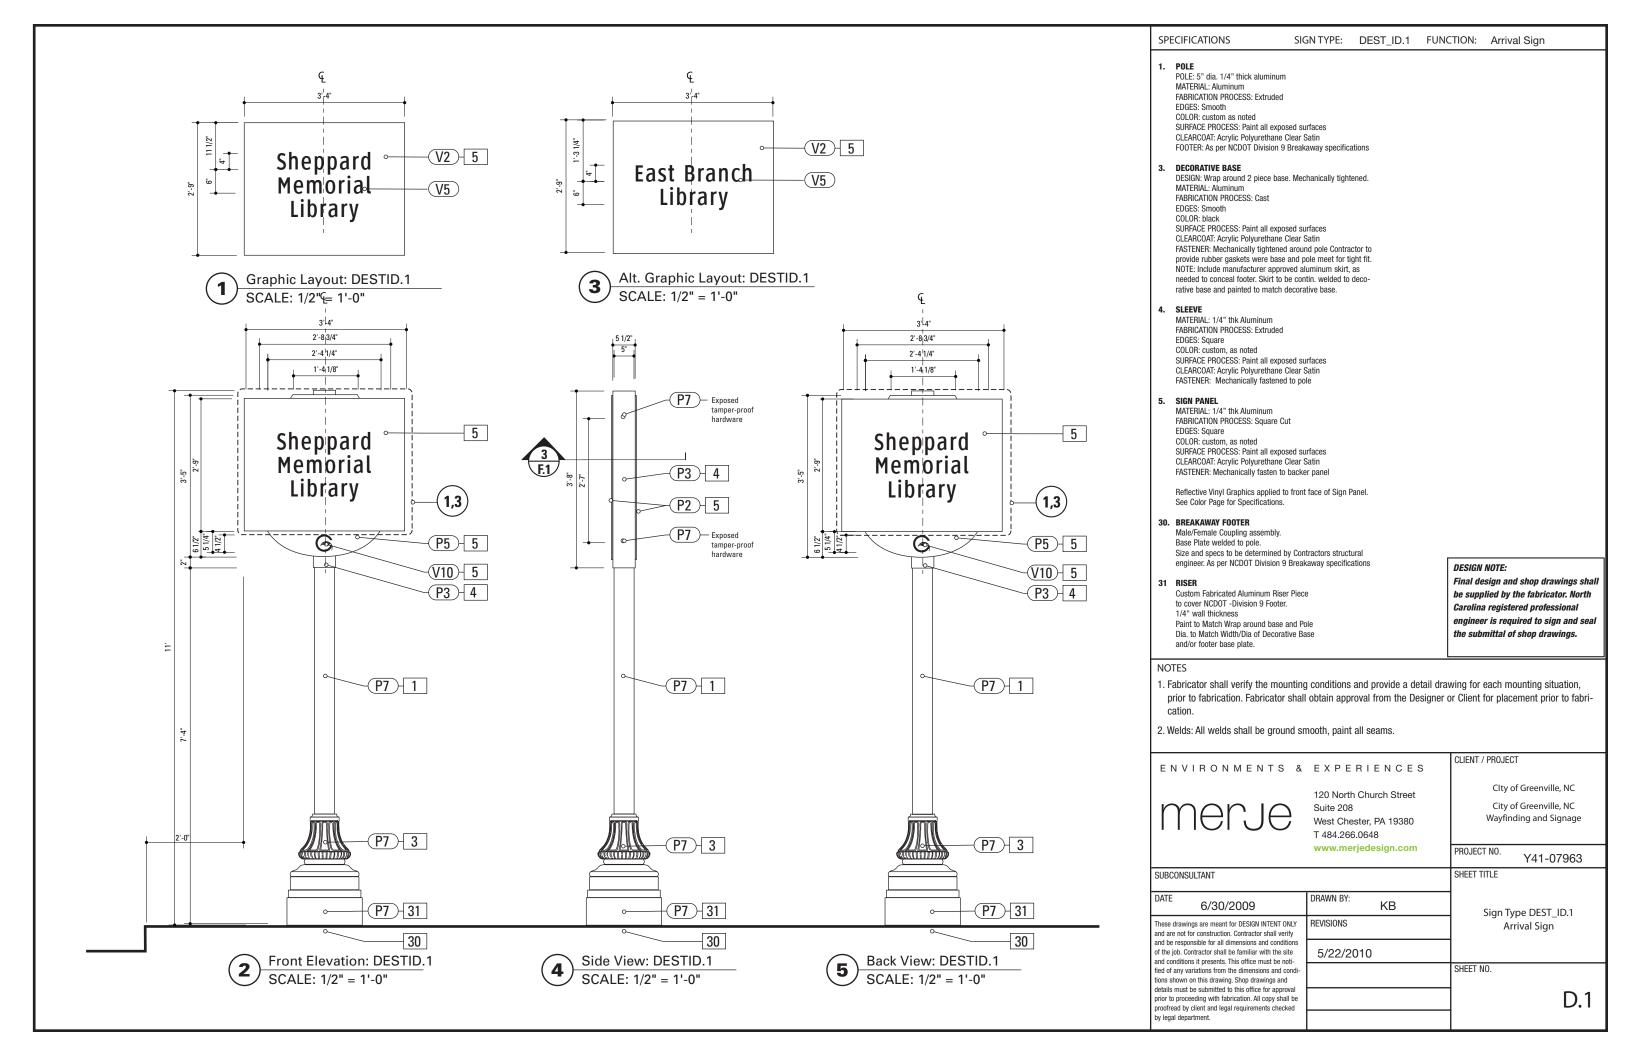

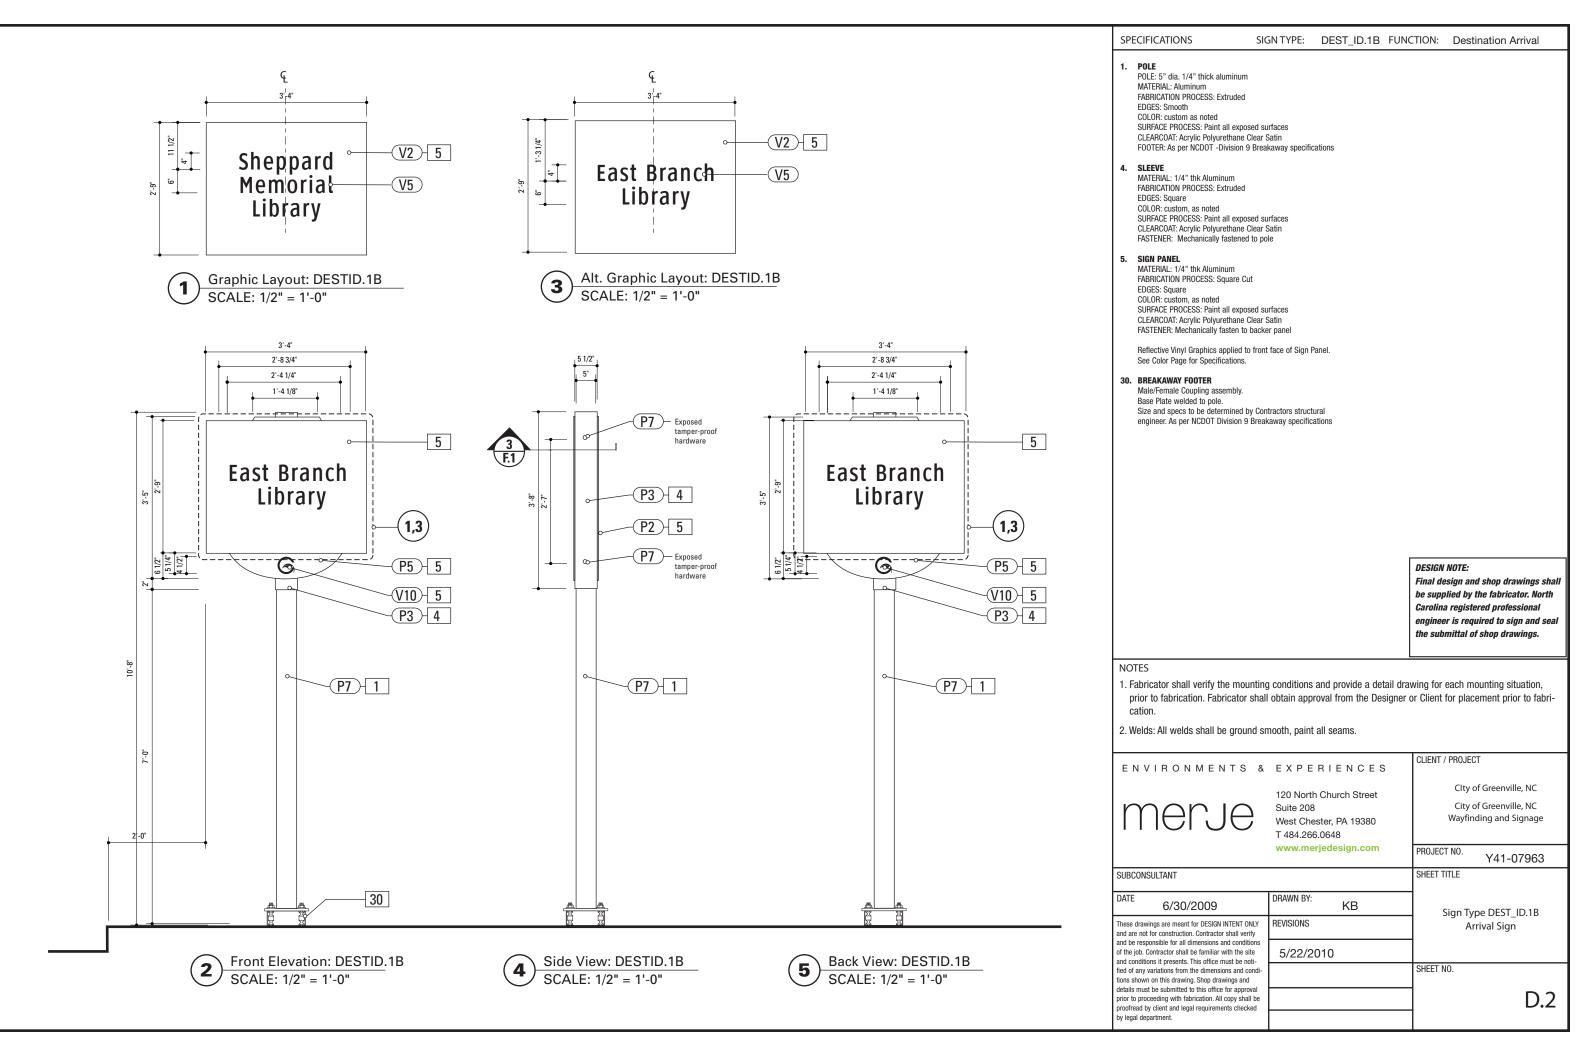

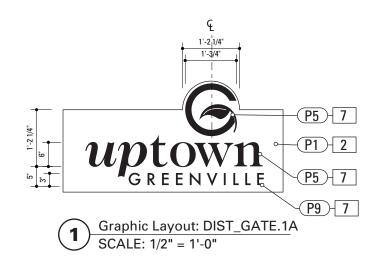

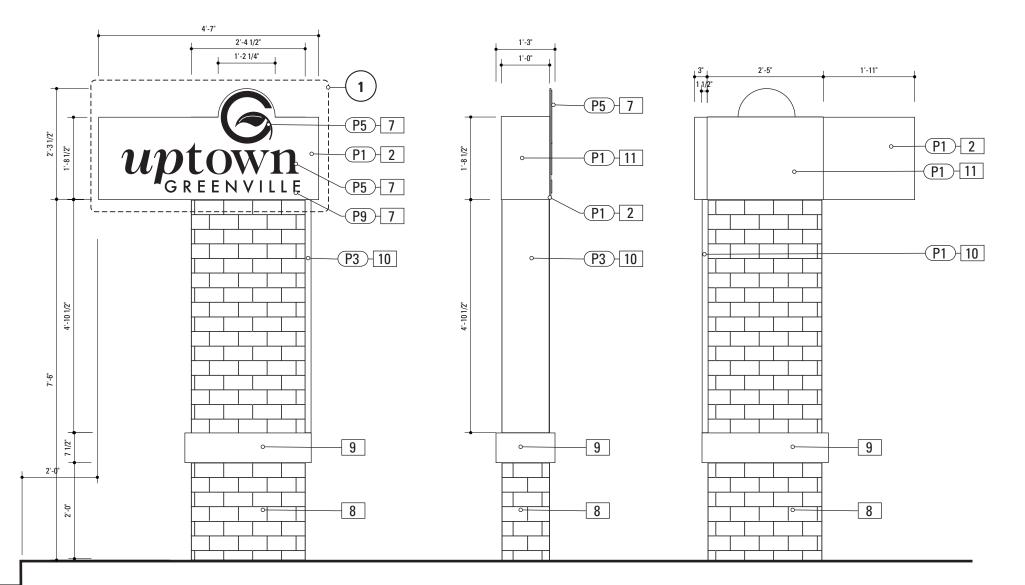

Front Elevation: DIST_GATE.1A

SCALE: 1/2" = 1'-0"

Side View: DIST_GATE.1A
SCALE: 1/2" = 1'-0"

Back View: DIST_GATE.1A

SCALE: 1/2" = 1'-0"

SPECIFICATIONS SIGN TYPE: DISTGATE.1A FUNCTION: District Gateway

2. SIGN PANEL

MATERIAL: 1/4" thk Aluminum
FABRICATION PROCESS: Router Cut
EDGES: Smooth
COLOR: custom, as noted
SURFACE PROCESS: Paint all exposed surfaces
CLEARCOAT: Acrylic Polyurethane Clear Satin
FASTENER: Mechanically fastened to sleeve

Vinyl Graphics applied to front face of Sign Panel. See Color Page for Specifications.

7. DIMENSIONAL GRAPHICS

MATERIAL: 1/4" thk Aluminum
FABRICATION PROCESS: Water Jet or Router cut
EDGES: Smooth
COLOR: custom, as noted
SURFACE PROCESS: Paint all exposed surfaces
CLEARCOAT: Acrylic Polyurethane Clear Satin
FASTENER: Chemical weld to sign panel

8. BRICK BAS

MATERIAL: Cinderblock base and brick to match uptown streetscape plan or approved equal FABRICATION PROCESS: Cinderblock base, cladded in brick EDGES: Square CORNERS: Square COLOR: Brick FOOTER: As per NCDOT Division 9 Breakaway specifications

9. STONE ACCENT

MATERIAL: Stone to match uptown streetscape plan or approved equal FABRICATION PROCESS: Match Master Plan Specification EDGES: Square CORNERS: Square COLOR: Match Master Plan Specification FASTENER: Match Master Plan Specification

10. ACCENT PANEL

MATERIAL: 1/2" thk Aluminum
FABRICATION PROCESS: Square Cut
EDGES: Square
COLOR: custom, as noted
SURFACE PROCESS: Paint all exposed surfaces
CLEARCOAT: Acrylic Polyurethane Clear Satin
FASTENER: Mechanically fastened to brick base

11. BRACKET


MATERIAL: 1/4" thk Aluminum
FABRICATION PROCESS: Extruded
EDGES: Square
COLOR: custom, as noted
SURFACE PROCESS: Paint all exposed surfaces
CLEARCOAT: Acrylic Polyurethane Clear Satin
FASTENER: Mechanically fastened to brick base

DESIGN NOTE:

Final design and shop drawings shall be supplied by the fabricator. North Carolina registered professional engineer is required to sign and seal the submittal of shop drawings.

- Fabricator shall verify the mounting conditions and provide a detail drawing for each mounting situation, prior to fabrication. Fabricator shall obtain approval from the Designer or Client for placement prior to fabrication.
- 2. Welds: All welds shall be ground smooth, paint all seams.



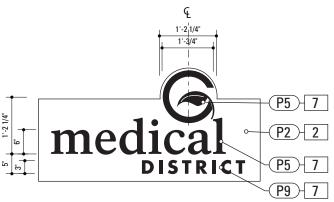


Alt. Graphic Layout: DIST_GATE.1B

SCALE: 1/2" = 1'-0"

Front Elevation: DIST_GATE.1B

SCALE: 1/2" = 1'-0"

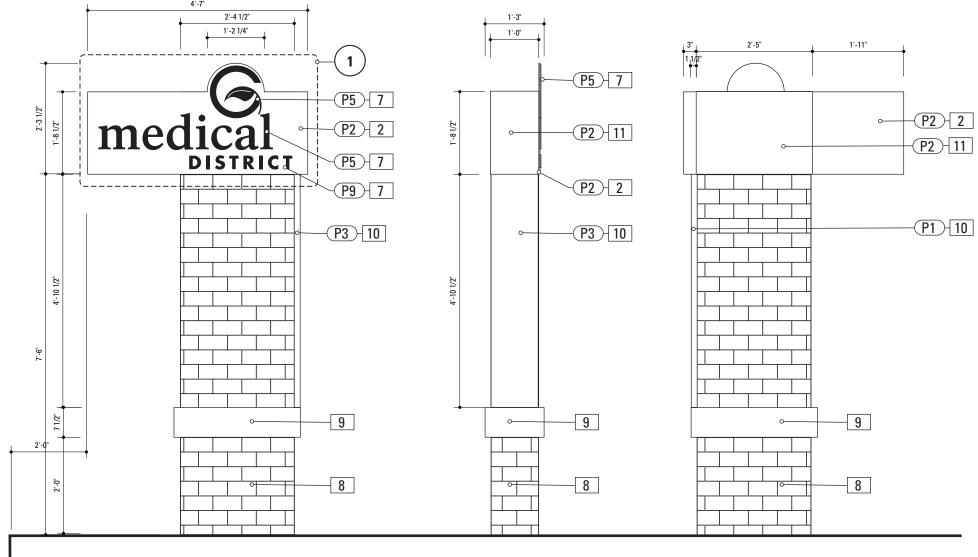

Side View: DIST_GATE.1B

SCALE: 1/2" = 1'-0"

Back View: DIST_GATE.1B
SCALE: 1/2" = 1'-0"

SPECIFICATIONS SIGN TYPE: DISTGATE.1B FUNCTION: District Gateway

2. SIGN PANEL

MATERIAL: 1/4" thk Aluminum
FABRICATION PROCESS: Router Cut
EDGES: Smooth
COLOR: custom, as noted
SURFACE PROCESS: Paint all exposed surfaces
CLEARCOAT: Acrylic Polyurethane Clear Satin
FASTENER: Mechanically fastened to sleeve

Vinyl Graphics applied to front face of Sign Panel. See Color Page for Specifications.

7. DIMENSIONAL GRAPHICS

MATERIAL: 1/4" thk Aluminum
FABRICATION PROCESS: Water Jet or Router cut
EDGES: Smooth
COLOR: custom, as noted
SURFACE PROCESS: Paint all exposed surfaces
CLEARCOAT: Acrylic Polyurethane Clear Satin
FASTENER: Chemical weld to sign panel

8. BRICK BASE

MATERIAL: Cinderblock base and brick to match uptown streetscape plan or approved equal FABRICATION PROCESS: Cinderblock base, cladded in brick EDGES: Square CORNERS: Square COLOR: Brick FOOTER: As per NCDOT Division 9 Breakaway specifications

9. STONE ACCENT

MATERIAL: Stone to match uptown streetscape plan or approved equal FABRICATION PROCESS: Match Master Plan Specification EDGES: Square CORNERS: Square COLOR: Match Master Plan Specification FASTENER: Match Master Plan Specification

10. ACCENT PANEL

MATERIAL: 1/2" thk Aluminum
FABRICATION PROCESS: Square Cut
EDGES: Square
COLOR: custom, as noted
SURFACE PROCESS: Paint all exposed surfaces
CLEARCOAT: Acrylic Polyurethane Clear Satin
FASTENER: Mechanically fastened to brick base

11. BRACKET


MATERIAL: 1/4" thk Aluminum
FABRICATION PROCESS: Extruded
EDGES: Square
COLOR: custom, as noted
SURFACE PROCESS: Paint all exposed surfaces
CLEARCOAT: Acrylic Polyurethane Clear Satin
FASTENER: Mechanically fastened to brick base

DESIGN NOTE:

Final design and shop drawings shall be supplied by the fabricator. North Carolina registered professional engineer is required to sign and seal the submittal of shop drawings.


- Fabricator shall verify the mounting conditions and provide a detail drawing for each mounting situation, prior to fabrication. Fabricator shall obtain approval from the Designer or Client for placement prior to fabrication.
- 2. Welds: All welds shall be ground smooth, paint all seams.

ENVIRONMENTS &	EXPERIENCES	CLIENT / PROJECT
merje	120 North Church Street Suite 208 West Chester, PA 19380 T 484.266.0648	CIty of Greenville, NC City of Greenville, NC Wayfinding and Signage
	www.merjedesign.com	PROJECT NO. Y41-07963
SUBCONSULTANT		SHEET TITLE
DATE 6/30/2009	DRAWN BY: KB	Sign Type DIST_GATE.1B
These drawings are meant for DESIGN INTENT ONLY and are not for construction. Contractor shall verify	REVISIONS	District Gateway
and be responsible for all dimensions and conditions of the job. Contractor shall be familiar with the site and conditions it presents. This office must be noti-	5/22/2010	
fied of any variations from the dimensions and condi- tions shown on this drawing. Shop drawings and		SHEET NO.
details must be submitted to this office for approval prior to proceeding with fabrication. All copy shall be proofread by client and legal requirements checked		D.4
by legal department.		

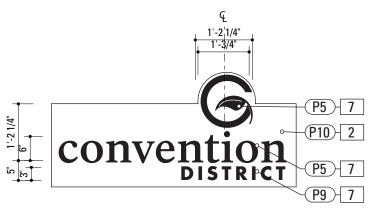

Graphic Layout: DIST_GATE.1C

SCALE: 1/2" = 1'-0"

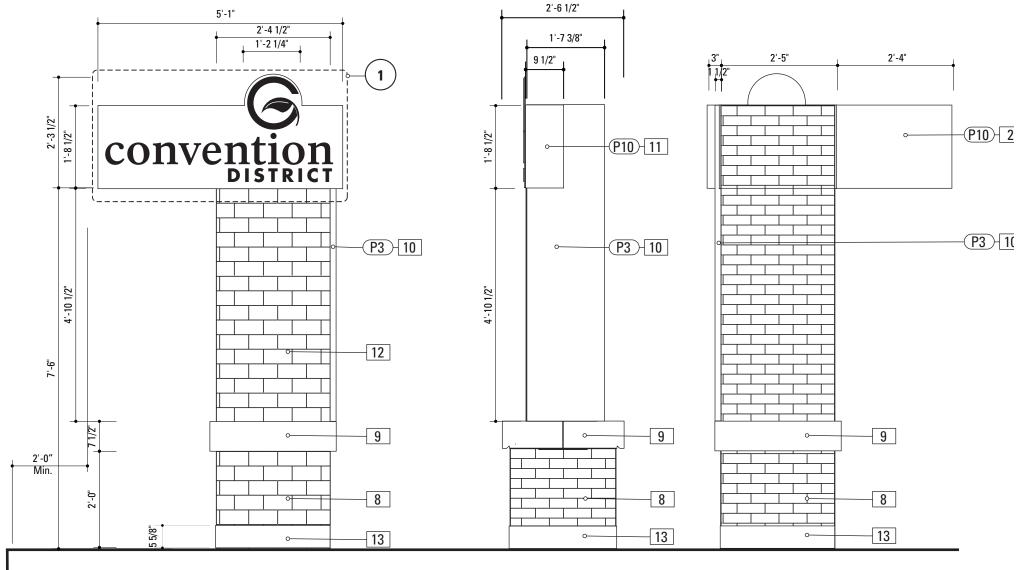

Front Elevation: DIST_GATE.1C
SCALE: 1/2" = 1'-0"

Side View: DIST_GATE.1C SCALE: 1/2" = 1'-0" Back View: DIST_GATE.1C
SCALE: 1/2" = 1'-0"

SPECIFICATIONS SIGN TYPE: DISTGATE.2C FUNCTION: District Gateway

MATERIAL: 1/4" thk Aluminum
FABRICATION PROCESS: Router Cut
EDGES: Smooth
COLOR: custom, as noted
SURFACE PROCESS: Paint all exposed surfaces
CLEARCOAT: Acrylic Polyurethane Clear Satin
FASTENER: Mechanically fastened to sleeve

Vinyl Graphics applied to front face of Sign Panel. See Color Page for Specifications.

7. DIMENSIONAL GRAPHICS

MATERIAL: 1/4" thk Aluminum
FABRICATION PROCESS: Water Jet or Router cut
EDGES: Smooth
COLOR: custom, as noted
SURFACE PROCESS: Paint all exposed surfaces
CLEARCOAT: Acrylic Polyurethane Clear Satin
FASTENER: Chemical weld to sign panel

8. BRICK BASE

MATERIAL: Cinderblock base and brick to match uptown streetscape plan or approved equal FABRICATION PROCESS: Cinderblock base, cladded in brick EDGES: Square CORNERS: Square COLOR: Brick FOOTER: As per NCDOT Division 9 Breakaway specifications

9. STONE ACCENT

MATERIAL: Stone to match uptown streetscape plan or approved equal FABRICATION PROCESS: Match Master Plan Specification EDGES: Square CORNERS: Square COLOR: Match Master Plan Specification FASTENER: Match Master Plan Specification

10. ACCENT PANEL

MATERIAL: 1/2" thk Aluminum
FABRICATION PROCESS: Square Cut
EDGES: Square
COLOR: custom, as noted
SURFACE PROCESS: Paint all exposed surfaces
CLEARCOAT: Acrylic Polyurethane Clear Satin
FASTENER: Mechanically fastened to brick base

11. BRACKET


MATERIAL: 1/4" thk Aluminum
FABRICATION PROCESS: Extruded
EDGES: Square
COLOR: custom, as noted
SURFACE PROCESS: Paint all exposed surfaces
CLEARCOAT: Acrylic Polyurethane Clear Satin
FASTENER: Mechanically fastened to brick base

DESIGN NOTE:


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- 2. Welds: All welds shall be ground smooth, paint all seams.



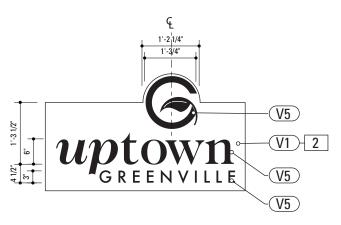

Graphic Layout: DIST_GATE.2A
SCALE: 1/2" = 1'-0"

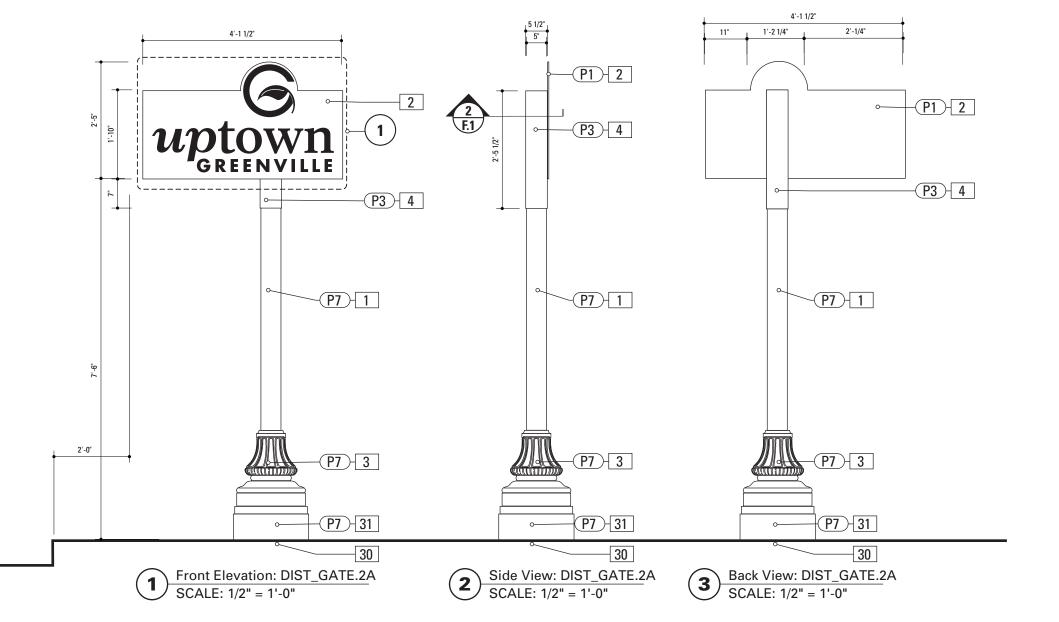

SPECIFICATIONS SIGN TYPE: DISTGATE.2A FUNCTION: District Gateway

1. P

POLE: 5" dia. 1/4" thick aluminum
MATERIAL: Aluminum
FABRICATION PROCESS: Extruded
EDGES: Smooth
COLOR: custom as noted
SURFACE PROCESS: Paint all exposed surfaces
CLEARCOAT: Acrylic Polyurethane Clear Satin
FOOTER: As per NCDOT Division 9 Breakaway specifications

2. SIGN PANEL

MATERIAL: 1/4" thk Aluminum
FABRICATION PROCESS: Router Cut
EDGES: Smooth
COLOR: custom, as noted
SURFACE PROCESS: Paint all exposed surfaces
CLEARCOAT: Acrylic Polyurethane Clear Satin
FASTENER: Mechanically fastened to sleeve

Reflective Vinyl Graphics applied to front face of Sign Panel. See Color Page for Specifications.

---- ----- - -g- --- -p------

DECORATIVE BASE

DESIGN: Wrap around 2 piece base. Mechanically tightened.
MATERIAL: Aluminum
FABRICATION PROCESS: Cast
EDGES: Smooth
COLOR: black
SURFACE PROCESS: Paint all exposed surfaces
CLEARCOAT: Acrylic Polyurethane Clear Satin
FASTENER: Mechanically tightened around pole Contractor to
provide rubber gaskets were base and pole meet for tight fit.
NOTE: Include manufacturer approved aluminum skirt, as
needed to conceal footer. Skirt to be contin. welded to decorative base and painted to match decorative base.

4. SLEEVE

MATERIAL: 1/4" thk Aluminum
FABRICATION PROCESS: Extruded
EDGES: Square
COLOR: custom, as noted
SURFACE PROCESS: Paint all exposed surfaces
CLEARCOAT: Acrylic Polyurethane Clear Satin
FASTENER: Mechanically fastened to pole

30. BREAKAWAY FOOTER

Male/Female Coupling assembly.
Base Plate welded to pole.
Size and specs to be determined by Contractors structural engineer. As per NCDOT Division 9 Breakaway specifications

31 RISER


Custom Fabricated Aluminum Riser Piece to cover NCDOT Footer. 1/4" wall thickness Paint to Match Wrap around base and Pole Dia. to Match Width/Dia of Decorative Base and/or footer base plate.

DESIGN NOTE:


Final design and shop drawings shall be supplied by the fabricator. North Carolina registered professional engineer is required to sign and seal the submittal of shop drawings.

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- 2. Welds: All welds shall be ground smooth, paint all seams.

EXPERIENCES	CLIENT / PROJECT
120 North Church Street Suite 208 West Chester, PA 19380 T 484.266.0648	CIty of Greenville, NC City of Greenville, NC Wayfinding and Signage
www.merjedesign.com	PROJECT NO. Y41-07963
	SHEET TITLE
DRAWN BY: KB	Sign Type DIST_GATE.2A
REVISIONS	District Gateway
5/22/2010	
	SHEET NO.
	D.6
	120 North Church Street Suite 208 West Chester, PA 19380 T 484.266.0648 www.merjedesign.com DRAWN BY: KB REVISIONS

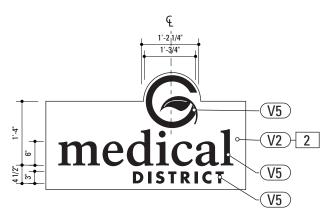

Alt. Graphic Layout: DIST_GATE.2B SCALE: 1/2" = 1'-0"

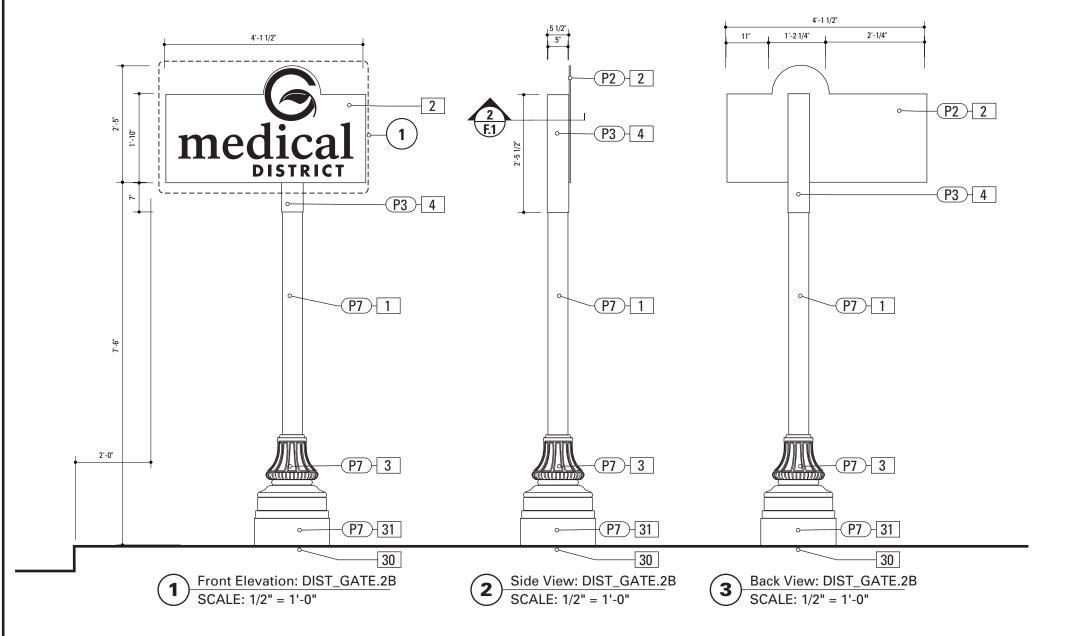

SPECIFICATIONS SIGN TYPE: DISTGATE.2B FUNCTION: District Gateway

| 1. P(

POLE: 5" dia. 1/4" thick aluminum
MATERIAL: Aluminum
FABRICATION PROCESS: Extruded
EDGES: Smooth
COLOR: custom as noted
SURFACE PROCESS: Paint all exposed surfaces
CLEARCOAT: Acrylic Polyurethane Clear Satin
FOOTER: As per NCDOT Division 9 Breakaway specifications

2. SIGN PANEL

MATERIAL: 1/4" thk Aluminum
FABRICATION PROCESS: Router Cut
EDGES: Smooth
COLOR: custom, as noted
SURFACE PROCESS: Paint all exposed surfaces
CLEARCOAT: Acrylic Polyurethane Clear Satin
FASTENER: Mechanically fastened to sleeve

Reflective Vinyl Graphics applied to front face of Sign Panel. See Color Page for Specifications.

3. DECORATIVE BASE

DESIGN: Wrap around 2 piece base. Mechanically tightened. MATERIAL: Aluminum FABRICATION PROCESS: Cast EDGES: Smooth COLOR: black SURFACE PROCESS: Paint all exposed surfaces CLEARCOAT: Acrylic Polyurethane Clear Satin FASTENER: Mechanically tightened around pole Contractor to provide rubber gaskets were base and pole meet for tight fit. NOTE: Include manufacturer approved aluminum skirt, as needed to conceal footer. Skirt to be contin. welded to decorative base and painted to match decorative base.

4. SLEEVE

MATERIAL: 1/4" thk Aluminum
FABRICATION PROCESS: Extruded
EDGES: Square
COLOR: custom, as noted
SURFACE PROCESS: Paint all exposed surfaces
CLEARCOAT: Acrylic Polyurethane Clear Satin
FASTENER: Mechanically fastened to pole

30. BREAKAWAY FOOTER

Male/Female Coupling assembly.
Base Plate welded to pole.
Size and specs to be determined by Contractors structural engineer. As per NCDOT Division 9 Breakaway specifications

31 RISER


Custom Fabricated Aluminum Riser Piece to cover NCDOT Footer. 1/4" wall thickness Paint to Match Wrap around base and Pole Dia. to Match Width/Dia of Decorative Base and/or footer base plate.

DESIGN NOTE:

Final design and shop drawings shall be supplied by the fabricator. North Carolina registered professional engineer is required to sign and seal the submittal of shop drawings.

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- 2. Welds: All welds shall be ground smooth, paint all seams.

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BCONSULTANT		SHEET TITLE
TE 6/30/2009	DRAWN BY: KB	Sign Type DIST_GATE.2B
se drawings are meant for DESIGN INTENT ONLY I are not for construction. Contractor shall verify	REVISIONS	District Gateway
be responsible for all dimensions and conditions he job. Contractor shall be familiar with the site conditions it presents. This office must be noti-	5/22/2010	
of any variations from the dimensions and condisis shown on this drawing. Shop drawings and		SHEET NO.
ails must be submitted to this office for approval or to proceeding with fabrication. All copy shall be ofread by client and legal requirements checked		D.7
anal department		

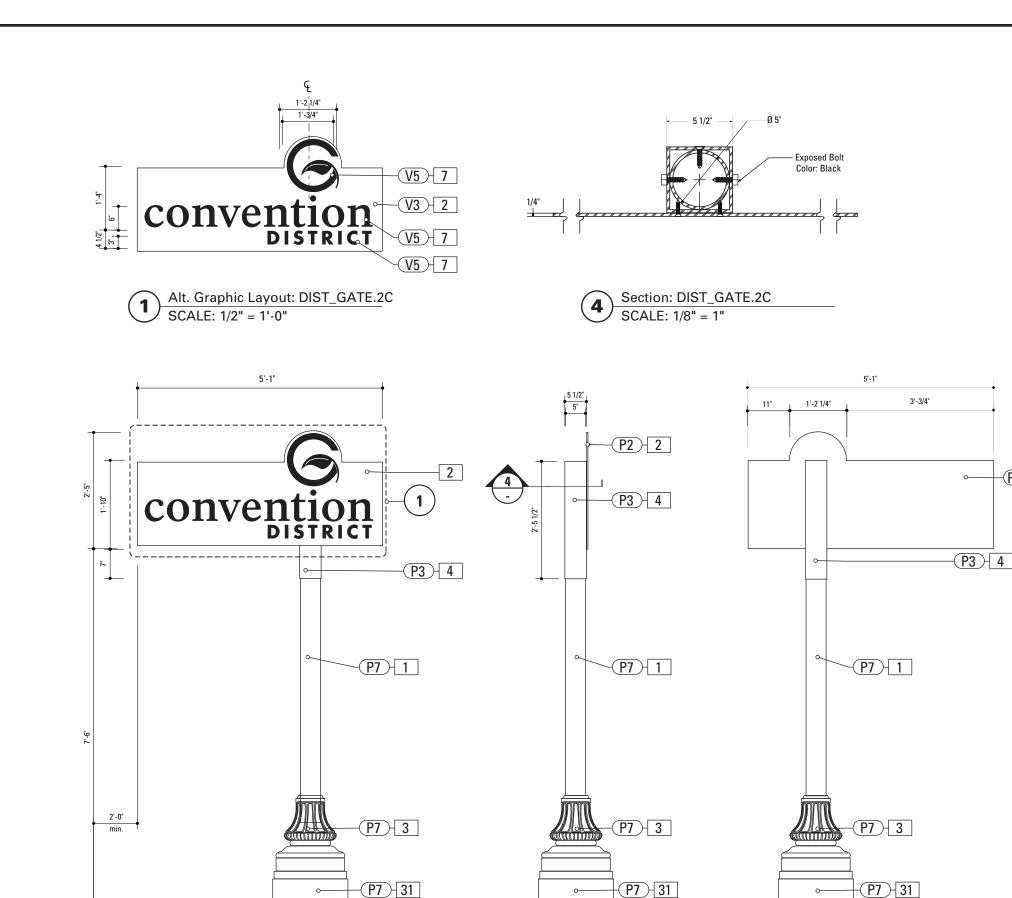

30

Front Elevation: DIST_GATE.2C

SCALE: 1/2" = 1'-0"

30

Side View: DIST_GATE.2C

SCALE: 1/2" = 1'-0"

SPECIFICATIONS SIGN TYPE: DISTGATE.2C FUNCTION: District Gateway

| 1. P(

POLE: 5" dia. 1/4" thick aluminum
MATERIAL: Aluminum
FABRICATION PROCESS: Extruded
EDGES: Smooth
COLOR: custom as noted
SURFACE PROCESS: Paint all exposed surfaces
CLEARCOAT: Acrylic Polyurethane Clear Satin
FOOTER: As per NCDOT Division 9 Breakaway specifications

2. SIGN PANEL

MATERIAL: 1/4" thk Aluminum
FABRICATION PROCESS: Router Cut
EDGES: Smooth
COLOR: custom, as noted
SURFACE PROCESS: Paint all exposed surfaces
CLEARCOAT: Acrylic Polyurethane Clear Satin
FASTENER: Mechanically fastened to sleeve

Reflective Vinyl Graphics applied to front face of Sign Panel. See Color Page for Specifications.

3. DECORATIVE BASE DESIGN: Wrap around 2 piece base. Mechanically tightened.

MATERIAL: Aluminum
FABRICATION PROCESS: Cast
EDGES: Smooth
COLOR: black
SURFACE PROCESS: Paint all exposed surfaces
CLEARCOAT: Acrylic Polyurethane Clear Satin
FASTENER: Mechanically tightened around pole Contractor to
provide rubber gaskets were base and pole meet for tight fit.
NOTE: Include manufacturer approved aluminum skirt, as
needed to conceal footer. Skirt to be contin. welded to decorative base and painted to match decorative base.

4. SLEEVE

P10 2

30

Back View: DIST_GATE.2C

SCALE: 1/2" = 1'-0"

MATERIAL: 1/4" thk Aluminum
FABRICATION PROCESS: Extruded
EDGES: Square
COLOR: custom, as noted
SURFACE PROCESS: Paint all exposed surfaces
CLEARCOAT: Acrylic Polyurethane Clear Satin
FASTENER: Mechanically fastened to pole

30. BREAKAWAY FOOTER

Male/Female Coupling assembly.
Base Plate welded to pole.
Size and specs to be determined by Contractors structural engineer. As per NCDOT Division 9 Breakaway specifica-

31 RISER


Custom Fabricated Aluminum Riser Piece to cover NCDOT Footer. 1/4" wall thickness Paint to Match Wrap around base and Pole Dia. to Match Width/Dia of Decorative Base and/or footer base plate.


DESIGN NOTE:


Final design and shop drawings shall be supplied by the fabricator. North Carolina registered professional engineer is required to sign and seal the submittal of shop drawings.

- Fabricator shall verify the mounting conditions and provide a detail drawing for each mounting situation, prior to fabrication. Fabricator shall obtain approval from the Designer or Client for placement prior to fabrication.
- 2. Welds: All welds shall be ground smooth, paint all seams.

ENVIRONMENTS &	EXPERIENCES	CLIENT / PROJECT
merje	120 North Church Street Suite 208 West Chester, PA 19380 T 484.266.0648	CIty of Greenville, NC City of Greenville, NC Wayfinding and Signage
	www.merjedesign.com	PROJECT NO. Y41-07963
SUBCONSULTANT		SHEET TITLE
DATE 6/30/2009	DRAWN BY: KB	Sign Type DIST_GATE.2C
These drawings are meant for DESIGN INTENT ONLY and are not for construction. Contractor shall verify	REVISIONS	District Gateway
and be responsible for all dimensions and conditions of the job. Contractor shall be familiar with the site and conditions it presents. This office must be noti-	5/22/2010	
fied of any variations from the dimensions and condi- tions shown on this drawing. Shop drawings and		SHEET NO.
details must be submitted to this office for approval prior to proceeding with fabrication. All copy shall be proofread by client and legal requirements checked by legal department.		D.8

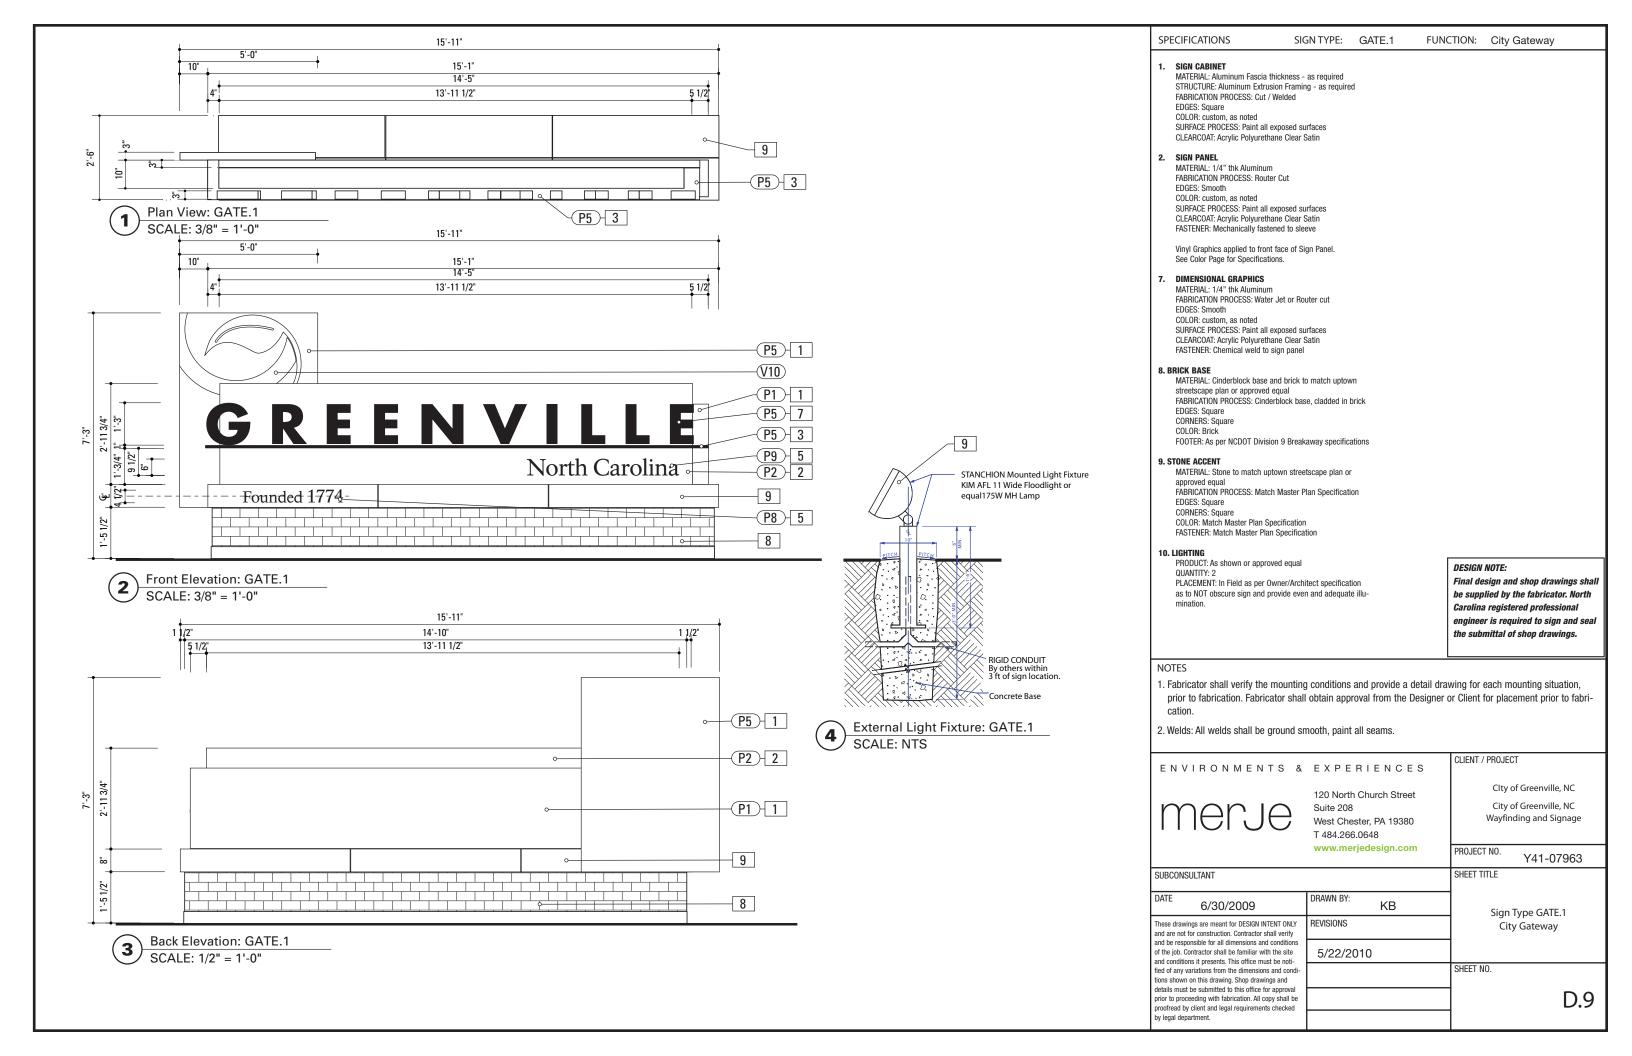

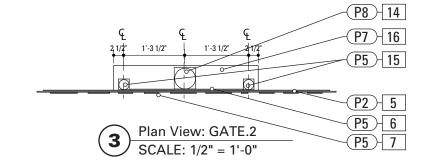

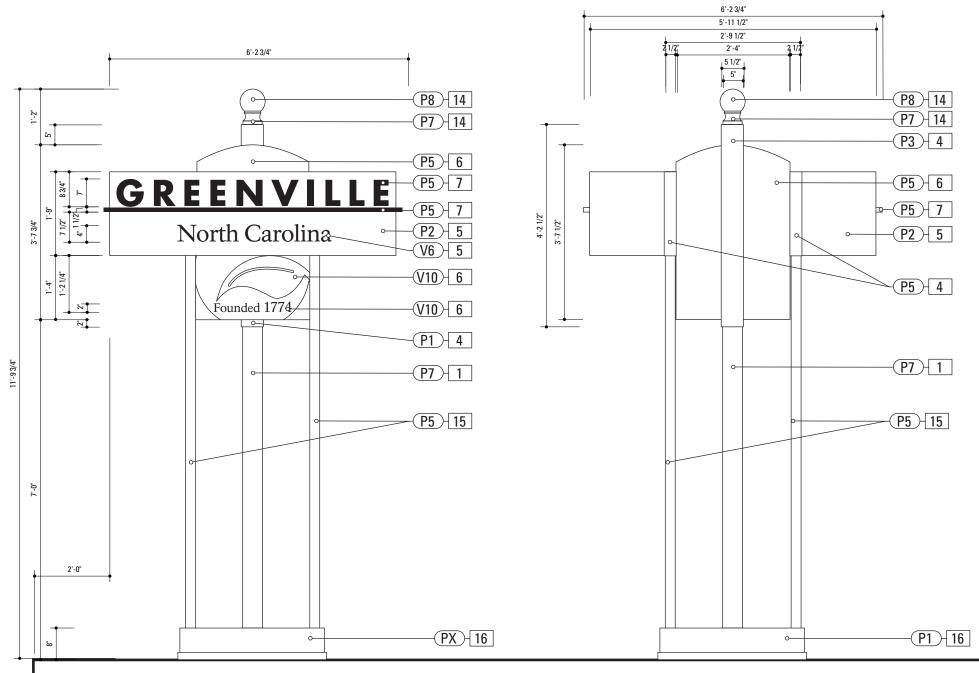

SPECIFICATIONS SIGN TYPE: GATE.2

POLE: 5" dia. 1/4" thick aluminum

MATERIAL: Aluminum FABRICATION PROCESS: Extruded

EDGES: Smooth COLOR: custom as noted SURFACE PROCESS: Paint all exposed surfaces CLEARCOAT: Acrylic Polyurethane MAP Clear Satin FOOTER: As per NCDOT Division 9 Breakaway specifications

BREAKAWAY FOOTER

Male/Female Coupling assembly Base Plate welded to pole. Size and specs to be determined by Contractors structural engineer. As per NCDOT Division 9 Breakaway specifica-

4. SLEEVE

MATERIAL: 1/4" thk Aluminum FABRICATION PROCESS: Extruded EDGES: Square COLOR: custom, as noted SURFACE PROCESS: Paint all exposed surfaces CLEARCOAT: Acrylic Polyurethane Clear Satin FASTENER: Mechanically fastened to pole

5. SIGN PANEL

MATERIAL: 1/4" thk Aluminum FABRICATION PROCESS: Square Cut EDGES: Square COLOR: custom, as noted SURFACE PROCESS: Paint all exposed surfaces CLEARCOAT: Acrylic Polyurethane Clear Satin FASTENER: Mechanically fastened to backer panel

Vinyl Graphics applied to front face of Sign Panel. See Color Page for Specifications.

BACKER PANEL

MATERIAL: 1/4" thk Aluminum FABRICATION PROCESS: Router Cut EDGES: Smooth COLOR: custom, as noted SURFACE PROCESS: Paint all exposed surfaces CLEARCOAT: Acrylic Polyurethane Clear Satin FASTENER: Mechanically fastened to sleeve

DIMENSIONAL GRAPHICS

MATERIAL: 1/4" thk Aluminum FABRICATION PROCESS: Water Jet or Router cut EDGES: Smooth COLOR: custom, as noted SURFACE PROCESS: Paint all exposed surfaces CLEARCOAT: Acrylic Polyurethane Clear Satin FASTENER: Chemical weld to sign panel

14. POLE CAP

PRODUCT: Cast Aluminum Post Top Finial MATERIAI · Aluminum FABRICATION PROCESS: Cast EDGES: Smooth COLOR: custom as noted SURFACE PROCESS: Paint all exposed surfaces CLEARCOAT: Acrylic Polyurethane Clear Satin FASTENER: Mechanically fasten to pole

FUNCTION: City Gateway

15. ACCENT POLEPOLE: 2 1/2" dia. 1/4" thick aluminum MATERIAL: Aluminum FABRICATION PROCESS: Extruded EDGES: Smooth COLOR: custom as noted SURFACE PROCESS: Paint all exposed surfaces CLEARCOAT: Acrylic Polyurethane Clear Satin FOOTER: Mechanically fastened to base

16. BASE

MATERIAL: 1/4" thk Aluminum FABRICATION PROCESS: Fabricated SIZE: as required to cover Breakaway FOOTER Assembly EDGES: Square COLOR: custom, as noted SURFACE PROCESS: Paint all exposed surfaces CLEARCOAT: Acrylic Polyurethane Clear Satin FASTENER: Mechanically fastened to poles

DESIGN NOTE:

Final design and shop drawings shall be supplied by the fabricator. North Carolina registered professional engineer is required to sign and seal the submittal of shop drawings.

NOTES


- 1. Fabricator shall verify the mounting conditions and provide a detail drawing for each mounting situation, prior to fabrication. Fabricator shall obtain approval from the Designer or Client for placement prior to fabri-
- 2. Welds: All welds shall be ground smooth, paint all seams.



Front Elevation: GATE.2

SCALE: 1/2" = 1'-0"

Back View: GATE.2 SCALE: 1/2" = 1'-0"

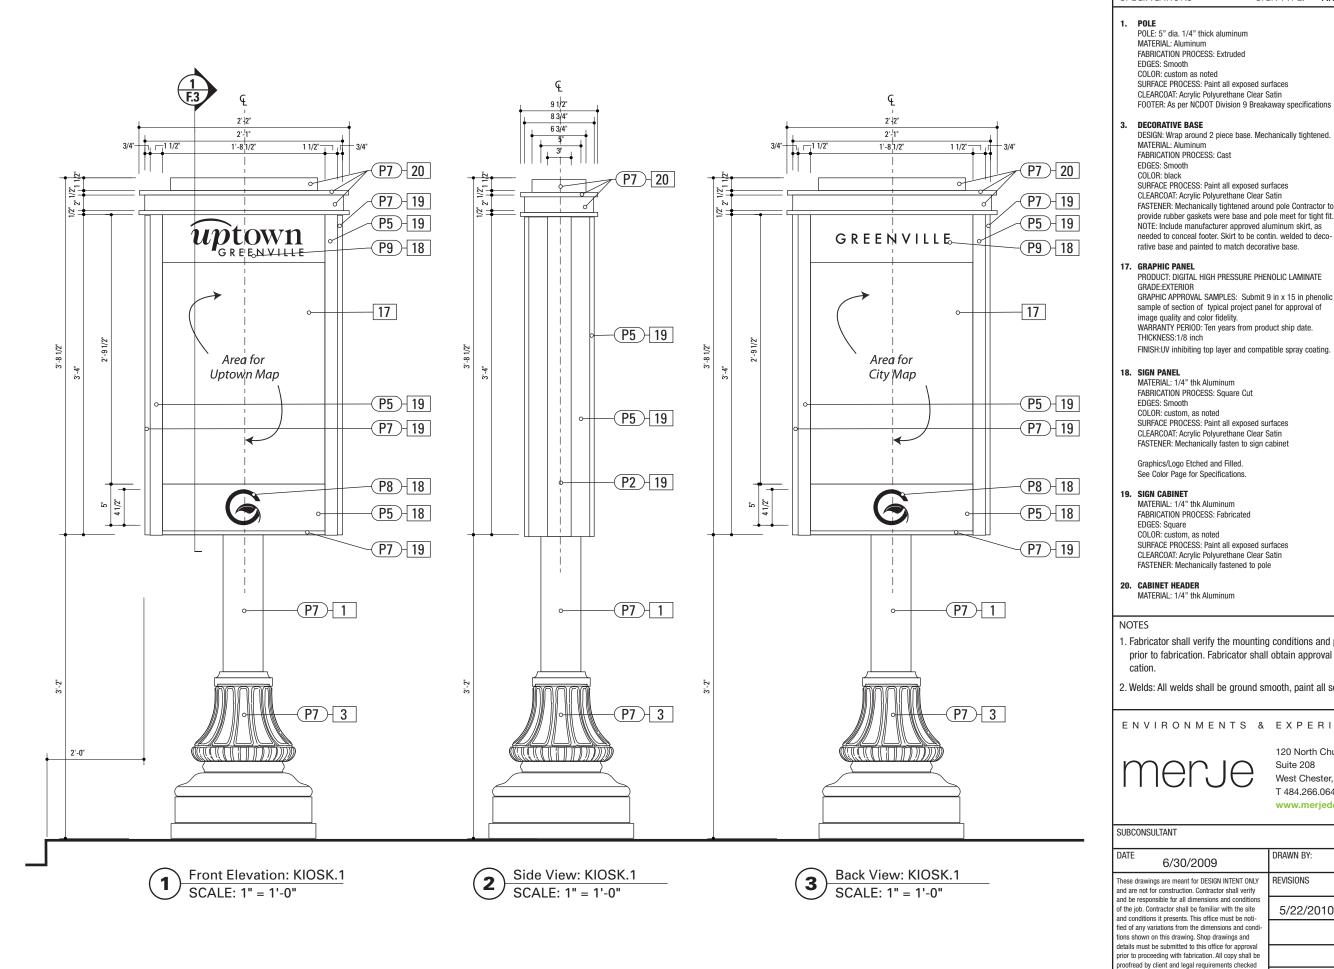

SPECIFICATIONS SIGN TYPE: KIOSK.1 FUNCTION: Pedestrian Kiosk

> COLOR: custom, as noted
> SURFACE PROCESS: Paint all exposed surfaces CLEARCOAT: Acrylic Polyurethane Clear Satin FASTENER: Mechanically fastened to sign cabinet

FABRICATION PROCESS: Extruded/Fabricated

EDGES: Square

FASTENER: Mechanically tightened around pole Contractor to provide rubber gaskets were base and pole meet for tight fit. NOTE: Include manufacturer approved aluminum skirt, as needed to conceal footer. Skirt to be contin. welded to deco-


GRADE:EXTERIOR
GRAPHIC APPROVAL SAMPLES: Submit 9 in x 15 in phenolic sample of section of typical project panel for approval of


DESIGN NOTE:


Final design and shop drawings shall be supplied by the fabricator. North Carolina registered professional engineer is required to sign and seal the submittal of shop drawings.

- 1. Fabricator shall verify the mounting conditions and provide a detail drawing for each mounting situation, prior to fabrication. Fabricator shall obtain approval from the Designer or Client for placement prior to fabri-
- 2. Welds: All welds shall be ground smooth, paint all seams.

ENVIRONMENTS &	EXPERIENCES	CLIENT / PROJECT
merje	120 North Church Street Suite 208 West Chester, PA 19380 T 484.266.0648	CIty of Greenville, NC City of Greenville, NC Wayfinding and Signage
	www.merjedesign.com	PROJECT NO. Y41-07963
BCONSULTANT		SHEET TITLE
TE 6/30/2009	DRAWN BY: KB	Sign Type KIOSK.1
ese drawings are meant for DESIGN INTENT ONLY I are not for construction. Contractor shall verify	REVISIONS	Pedestrian Kiosk
be responsible for all dimensions and conditions he job. Contractor shall be familiar with the site conditions it presents. This office must be noti-	5/22/2010	
I of any variations from the dimensions and condi- is shown on this drawing. Shop drawings and		SHEET NO.
ails must be submitted to this office for approval or to proceeding with fabrication. All copy shall be ofread by client and legal requirements checked		D.11

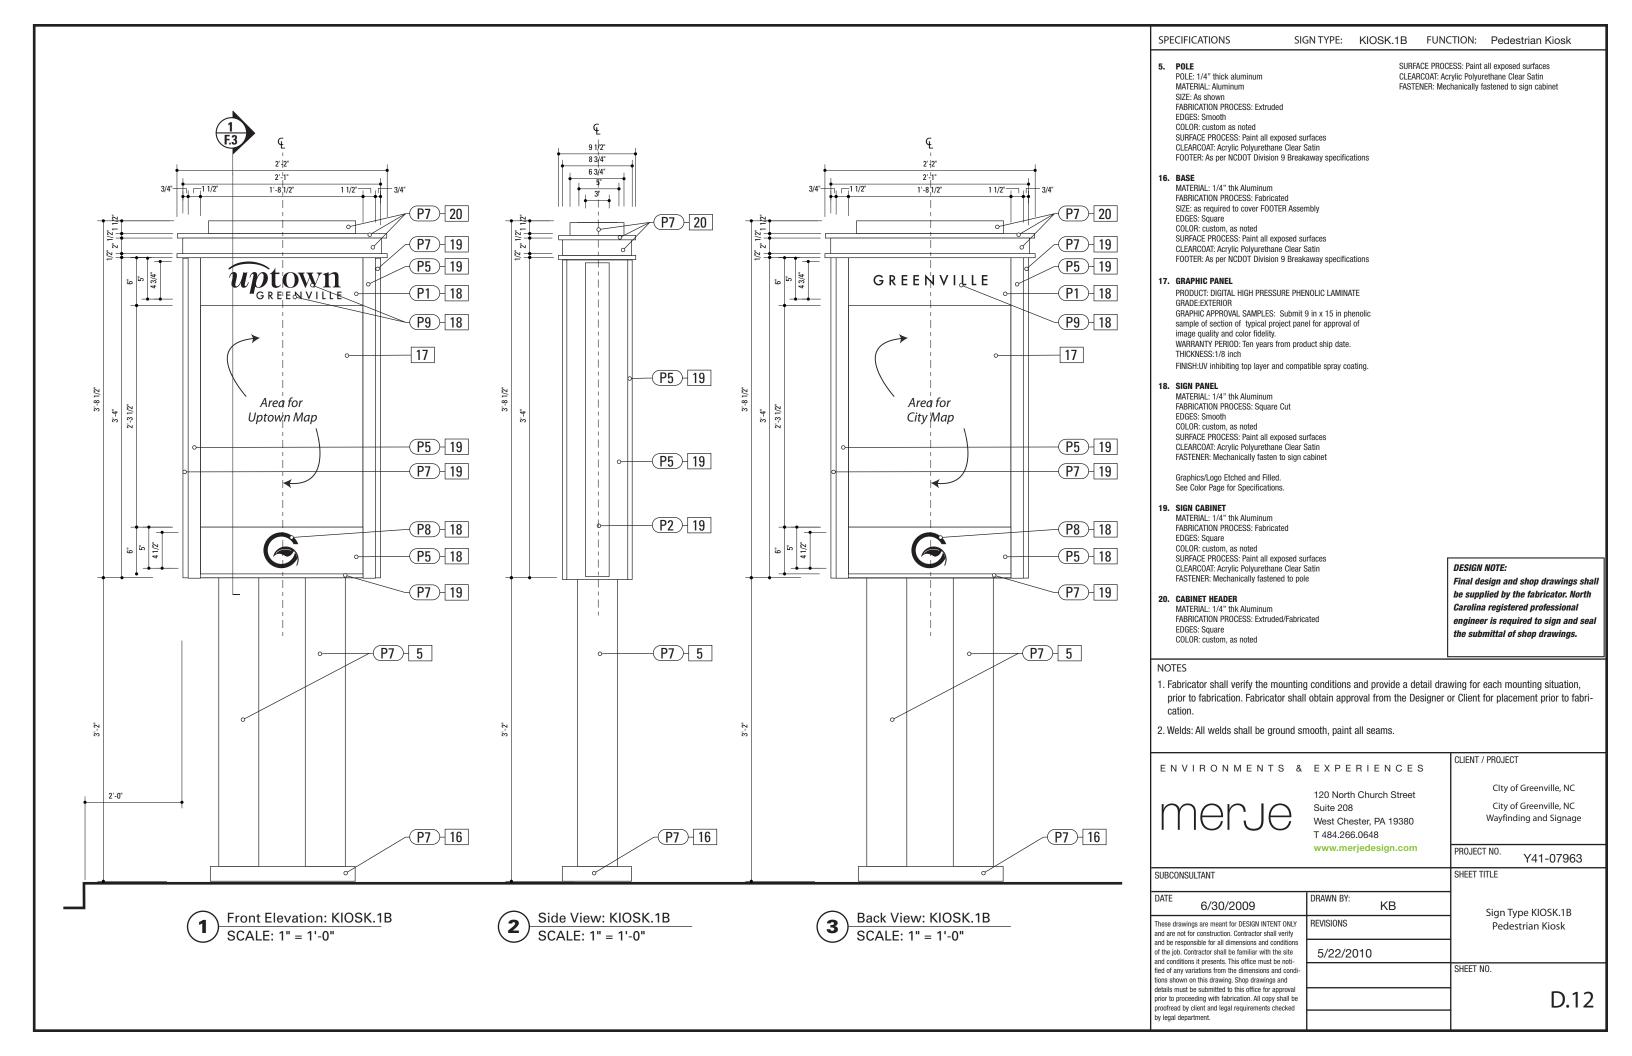

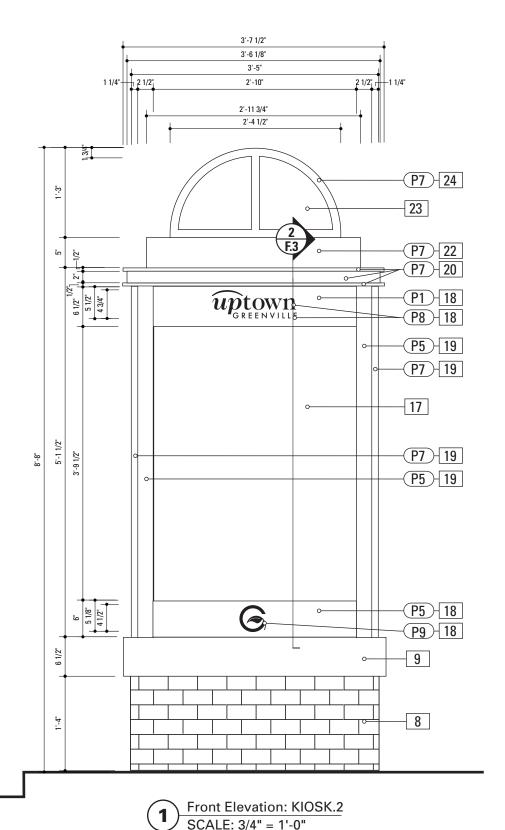

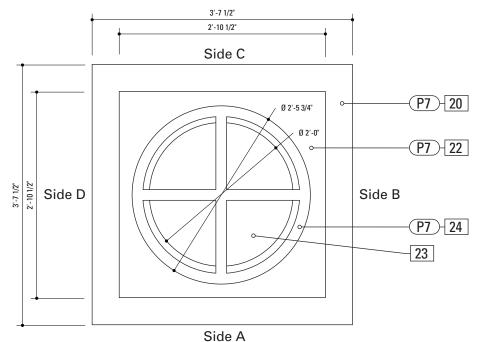

Plan View: KIOSK.2 SCALE: 3/4" = 1'-0"

KIOSK.2 Content	
Side A	Uptown Map
Side B	City Map
Side C	Bulletin Board
Side D	Poster / Advertisement

SPECIFICATIONS SIGN TYPE: KIOSK.2 FUNCTION: Pedestrian Kiosk

8. BRICK BASE

MATERIAL: Cinderblock base and brick to match uptown streetscape plan or approved equal FABRICATION PROCESS: Cinderblock base, cladded in brick

EDGES: Square CORNERS: Square COLOR: Brick

FOOTER: Direct Burial

9. STONE ACCENT

MATERIAL: Stone to match uptown streetscape plan or approved equal

FABRICATION PROCESS: Match Master Plan Specification EDGES: Square CORNERS: Square

COLOR: Stone Match Master Plan Specification FASTENER: Match Master Plan Specification

17. GRAPHIC PANEL-Side A/B/D

and color fidelity.

PRODUCT: Professional Duratrans GRAPHIC APPROVAL SAMPLES: Submit 9 in x 15 sample of section of typical project panel for approval of image quality

WARRANTY PERIOD: Ten years from product ship date. THICKNESS:9ml

FINISH:UV inhibiting top layer

Contractor to supply fabrication details for adhering/holding and changing graphic panel

LIGHTING: Internally Illuminated - color temperature of 4000 ± 1000 K, a Color Rendering Index (CRI) of 85 to 100, and an illuminance of at least 50 footcandles (538 lux). General Electric Deluxe Cool White Fluorescent Lamps (or similar lamps made by several manufacturers) meet these conditions. You can also use warmer lamps such as the Phillips 5000 K Ultralume, or a mixture of incandescent and fluorescent lamps. For each pair of 40-watt cool white deluxe fluorescent lamps, use a 75-watt frosted tungsten

17. GRAPHIC PANEL-Side C

PRODUCT NAME: Full Hinged Cabinet/Lockable outdoor corkboard display posters, schedules and notices MATERIAL: aluminum extrusions with rust resistant fasteners. Two key locks - closed cell foam seal -impact resistant acrylic lens- rubber gasket seals between the door frame

18. SIGN PANEL

MATERIAL: 1/4" thk Aluminum FABRICATION PROCESS: Square Cut EDGES: Smooth COLOR: custom as noted SURFACE PROCESS: Paint all exposed surfaces CLEARCOAT: Acrylic Polyurethane Clear Satin FASTENER: Mechanically fasten to sign cabinet Graphics/Logo Etched and Filled.

19. SIGN CABINET

MATERIAL: 1/4" thk Aluminum FABRICATION PROCESS: Fabricated EDGES: Square

COLOR: custom, as noted SURFACE PROCESS: Paint all exposed surfaces CLEARCOAT: Acrylic Polyurethane Clear Satin FASTENER: Mechanically fastened to pole

20. CABINET HEADER

MATERIAL: 1/4" thk Aluminum FABRICATION PROCESS: Extruded/Fabricated EDGES: Square COLOR: custom, as noted SURFACE PROCESS: Paint all exposed surfaces CLEARCOAT: Acrylic Polyurethane Clear Satin FASTENER: Mechanically fastened to sign cabinet

22. LIGHTING CABINET

MATERIAL: 1/4" thk Aluminum

FABRICATION PROCESS: Fabricated EDGES: Square COLOR: custom, as noted SURFACE PROCESS: Paint all exposed surfaces CLEARCOAT: Acrylic Polyurethane Clear Satin FASTENER: Mechanically fastened to cabinet header LIGHTING:Contractor to Provide exact number of fixtures to provide even illumination without shadows or hotspots. Power Requirement: 120 V

Power to be provided by others within 3 feet of Unit.

23. DOME

MATERIAL: 1/4" translucent frosted white plastic dome FABRICATION PROCESS: Extruded/Fabricated FDGFS: Smooth COLOR: translucent frosted white CLEARCOAT: Acrylic Polyurethane Clear Satin FASTENER: Mechanically fastened to lighting cabinet LIGHTING: Internally illuminated with LED fixture(s) Contractor to Provide exact number of fixtures to provide even illumination without shadows or hotspots. Power Requirement: 120 V


Power to be provided by others within 5 feet of Unit. 24. DOME ACCENTS


MATERIAL: 1/4" thk Aluminum bar stock FABRICATION PROCESS: Extruded/Cut/Formed EDGES: Smooth COLOR: custom, as noted FASTENER: mechanically fasten to lighting cabinet

DESIGN NOTE:

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- 2. Welds: All welds shall be ground smooth, paint all seams.



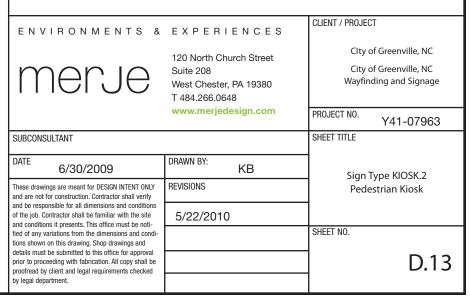

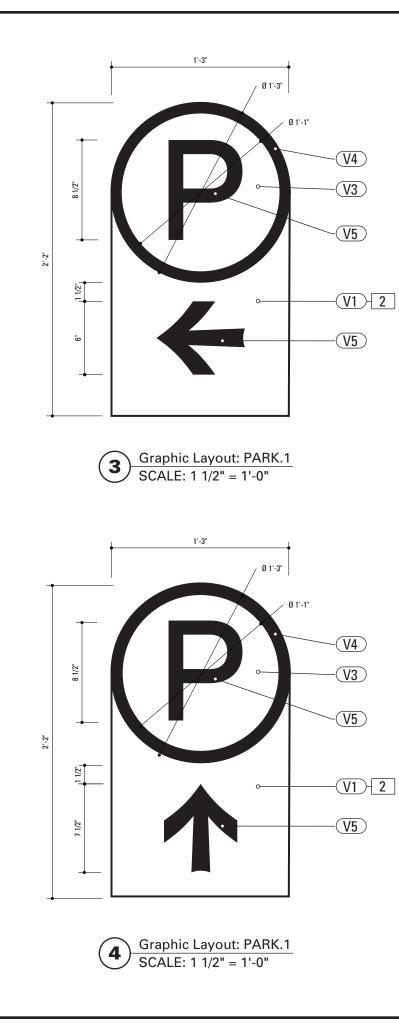5 1/2" 5"

Side View: PARK.1

SCALE: 1/2" = 1'-0"

2

-(P7)-1

Front Elevation: PARK.1

SCALE: 1/2" = 1'-0"

2

P7 4

P7 1

1'-3"

SPECIFICATIONS SIGN TYPE: PARK.1 FUNCTION: Parking Directional

1. POI

POLE: 5" dia. 1/4" thick aluminum
MATERIAL: Aluminum
FABRICATION PROCESS: Extruded
EDGES: Smooth
COLOR: custom as noted
SURFACE PROCESS: Paint all exposed surfaces
CLEARCOAT: Acrylic Polyurethane Clear Satin
FOOTER: As per NCDOT Division 9 Breakaway specifications

2. SIGN PANEL

MATERIAL: 1/4" thk Aluminum
FABRICATION PROCESS: Square Cut
EDGES: Square
COLOR: custom, as noted
SURFACE PROCESS: Paint all exposed surfaces
CLEARCOAT: Acrylic Polyurethane Clear Satin
FASTENER: Mechanically fasten to backer panel

Reflective Vinyl Graphics applied to front face of Sign Panel. See Color Page for Specifications.

4. SLEEVE

MATERIAL: 1/4" thk Aluminum
FABRICATION PROCESS: Extruded
EDGES: Square
COLOR: custom, as noted
SURFACE PROCESS: Paint all exposed surfaces
CLEARCOAT: Acrylic Polyurethane Clear Satin
FASTENER: Mechanically fastened to pole

30. BREAKAWAY FOOTER

Male/Female Coupling assembly.
Base Plate welded to pole.
Size and specs to be determined by Contractors structural engineer. As per NCDOT Division 9 Breakaway specifications


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CLIENT / PROJECT ENVIRONMENTS & EXPERIENCES Clty of Greenville, NC 120 North Church Street City of Greenville, NC Suite 208 Wayfinding and Signage West Chester, PA 19380 T 484.266.0648 www.merjedesign.com PROJECT NO. Y41-07963 SHEET TITLE SUBCONSULTANT DRAWN BY: KΒ 6/30/2009 Sign Type PARK.1 REVISIONS These drawings are meant for DESIGN INTENT ONLY Parking Directional and are not for construction. Contractor shall verify and be responsible for all dimensions and condition of the job. Contractor shall be familiar with the site 5/22/2010 and conditions it presents. This office must be noti-SHEET NO. fied of any variations from the dimensions and cond tions shown on this drawing. Shop drawings and details must be submitted to this office for approval D.14 prior to proceeding with fabrication. All copy shall be proofread by client and legal requirements checked by legal department.



SPECIFICATIONS SIGN TYPE: PARK.2 FUNCTION: Parking Directional

2. SIGN PANEL

MATERIAL: 1/4" thk Aluminum
FABRICATION PROCESS: Router Cut
EDGES: Smooth
COLOR: custom, as noted
SURFACE PROCESS: Paint all exposed surfaces
CLEARCOAT: Acrylic Polyurethane Clear Satin
FASTENER: Mechanically fastened to strap

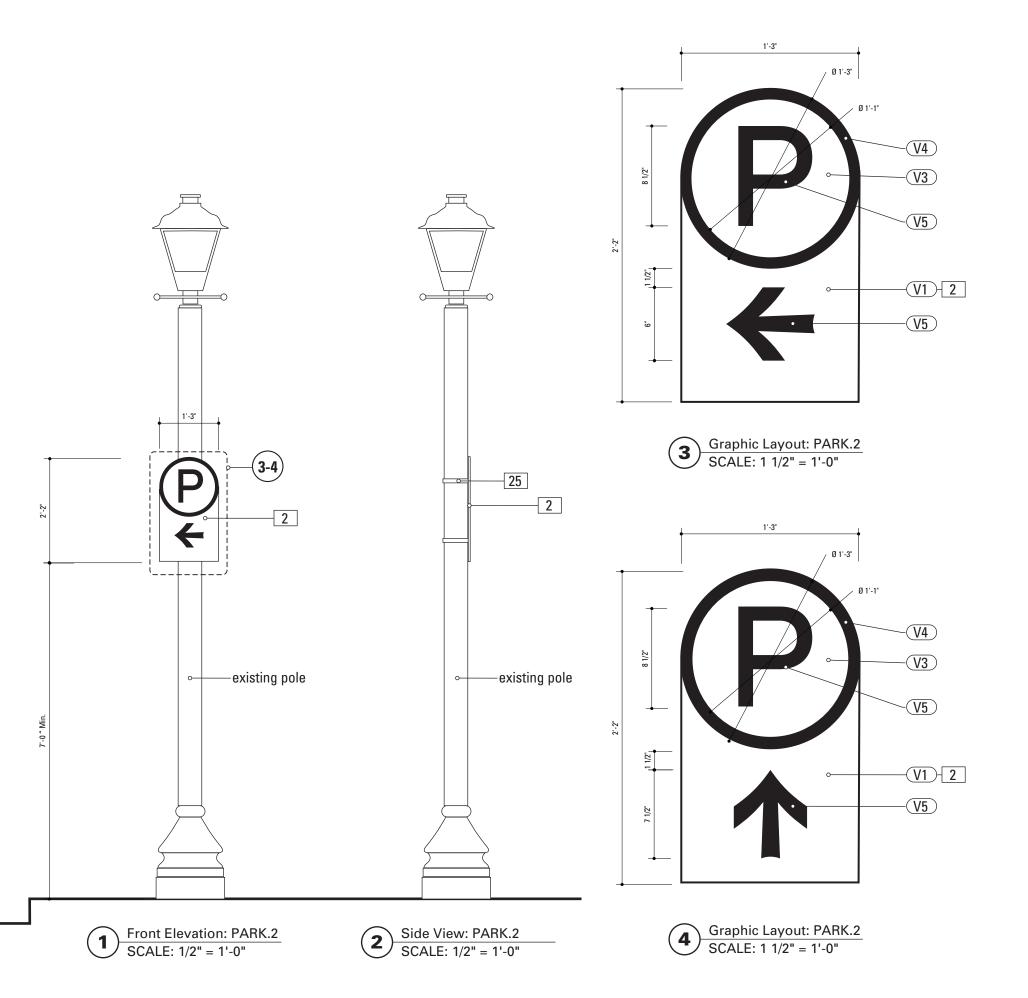Reflective Vinyl Graphics applied to front face of Sign Panel. See Color Page for Specifications.

25. STRAP

MATERIAL: Stainless steel with threaded tightening assembly including hardware
MOUNTING: Adjustable for utility and street poles (round square up to 10" dia.)
COLOR: Painted to match existing pole
QUANTITY: 2 per sign
HARDWARE: As required - located on panel not interfere with graphic sign elements.


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SPECIFICATIONS SIGN TYPE: PARK.3 FUNCTION: Parking Directional

1. P

POLE: 5" dia. 1/4" thick aluminum
MATERIAL: Aluminum
FABRICATION PROCESS: Extruded
EDGES: Smooth
COLOR: custom as noted
SURFACE PROCESS: Paint all exposed surfaces
CLEARCOAT: Acrylic Polyurethane Clear Satin
FOOTER: As per NCDOT Division 9 Breakaway specifications

2. SIGN PANEL

MATERIAL: 1/4" thk Aluminum
FABRICATION PROCESS: Square Cut
EDGES: Square
COLOR: custom, as noted
SURFACE PROCESS: Paint all exposed surfaces
CLEARCOAT: Acrylic Polyurethane Clear Satin
FASTENER: Mechanically fasten to backer panel

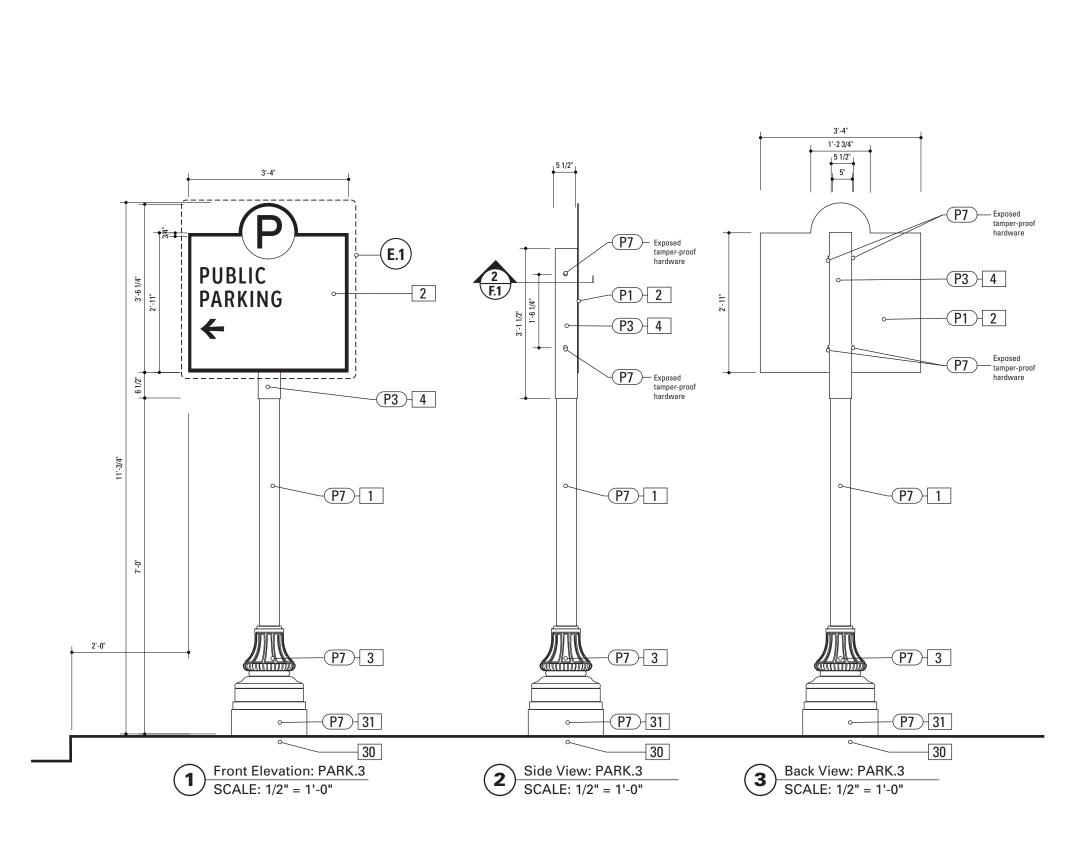Reflective Vinyl Graphics applied to front face of Sign Panel. See Color Page for Specifications.

3. DECORATIVE BASE DESIGN: Wrap around 2 piece base. Mechanically tightened.

MATERIAL: Aluminum
FABRICATION PROCESS: Cast
EDGES: Smooth
COLOR: black
SURFACE PROCESS: Paint all exposed surfaces
CLEARCOAT: Acrylic Polyurethane Clear Satin
FASTENER: Mechanically tightened around pole Contractor to
provide rubber gaskets were base and pole meet for tight fit.
NOTE: Include manufacturer approved aluminum skirt, as
needed to conceal footer. Skirt to be contin. welded to decorative base and painted to match decorative base.

4. SLEEVE

MATERIAL: 1/4" thk Aluminum
FABRICATION PROCESS: Extruded
EDGES: Square
COLOR: custom, as noted
SURFACE PROCESS: Paint all exposed surfaces
CLEARCOAT: Acrylic Polyurethane Clear Satin
FASTENER: Mechanically fastened to pole

30. BREAKAWAY FOOTER

Male/Female Coupling assembly.
Base Plate welded to pole.
Size and specs to be determined by Contractors structural engineer. As per NCDOT Division 9 Breakaway specifications

31 RISER


Custom Fabricated Aluminum Riser Piece to cover NCDOT Footer. 1/4" wall thickness Paint to Match Wrap around base and Pole Dia. to Match Width/Dia of Decorative Base and/or footer base plate.

DESIGN NOTE:

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- Fabricator shall verify the mounting conditions and provide a detail drawing for each mounting situation, prior to fabrication. Fabricator shall obtain approval from the Designer or Client for placement prior to fabrication.
- 2. Welds: All welds shall be ground smooth, paint all seams.

ENVIRONMENTS &	EXPERIENCES	CLIENT / PROJECT	
merje	120 North Church Street Suite 208 West Chester, PA 19380 T 484.266.0648	Clty of Greenville, NC City of Greenville, NC Wayfinding and Signage	
	www.merjedesign.com	PROJECT NO. Y41-07963	
SUBCONSULTANT		SHEET TITLE	
DRAWN BY: KB		Sign Type PARK.3	
These drawings are meant for DESIGN INTENT ONLY and are not for construction. Contractor shall verify	REVISIONS	Parking Directional	
and be responsible for all dimensions and conditions of the job. Contractor shall be familiar with the site and conditions it presents. This office must be noti-	5/22/2010		
fied of any variations from the dimensions and condi- tions shown on this drawing. Shop drawings and		SHEET NO.	
details must be submitted to this office for approval prior to proceeding with fabrication. All copy shall be proofread by client and legal requirements checked		D.16	

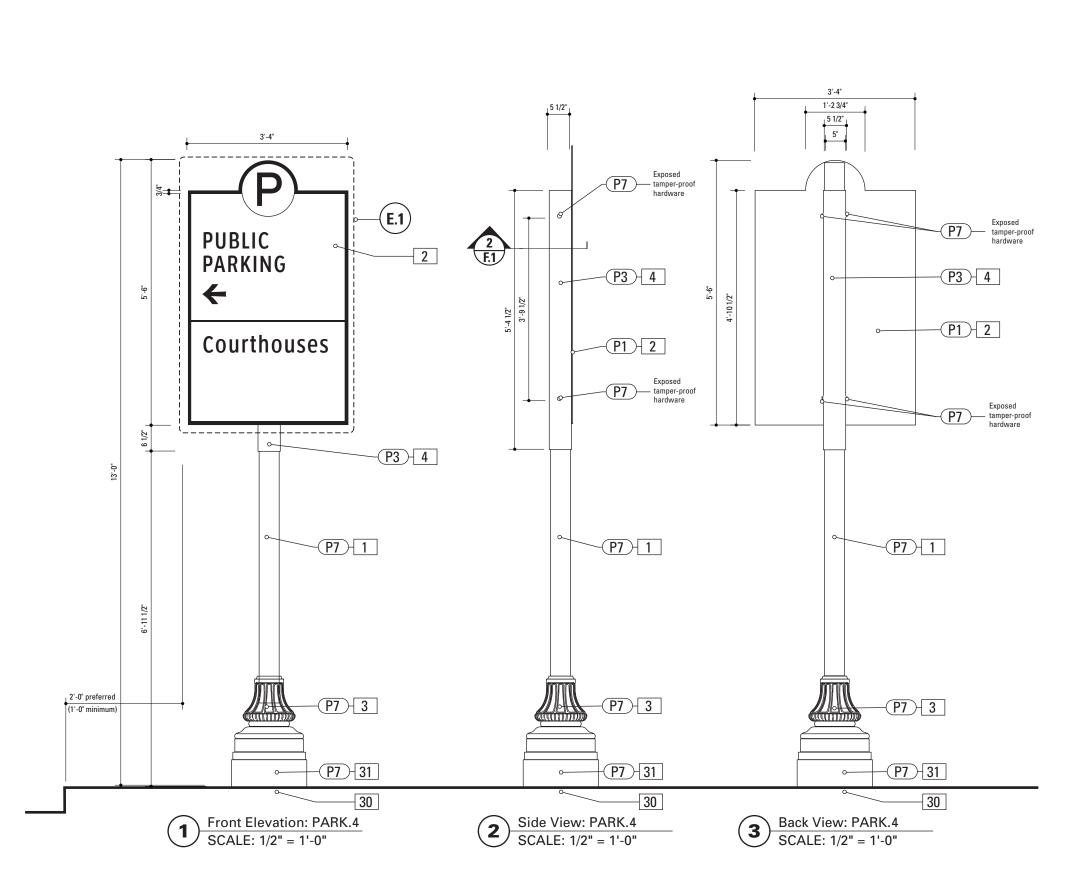

SPECIFICATIONS SIGN TYPE: PARK.4 FUNCTION: Parking Directional

1. P

POLE: 5" dia. 1/4" thick aluminum
MATERIAL: Aluminum
FABRICATION PROCESS: Extruded
EDGES: Smooth
COLOR: custom as noted
SURFACE PROCESS: Paint all exposed surfaces
CLEARCOAT: Acrylic Polyurethane Clear Satin
FOOTER: As per NCDOT Division 9 Breakaway specifications

2. SIGN PANEL

MATERIAL: 1/4" thk Aluminum
FABRICATION PROCESS: Square Cut
EDGES: Square
COLOR: custom, as noted
SURFACE PROCESS: Paint all exposed surfaces
CLEARCOAT: Acrylic Polyurethane Clear Satin
FASTENER: Mechanically fasten to backer panel

Reflective Vinyl Graphics applied to front face of Sign Panel. See Color Page for Specifications.

3. DECORATIVE BASE DESIGN: Wrap around 2 piece base. Mechanically tightened.

MATERIAL: Aluminum
FABRICATION PROCESS: Cast
EDGES: Smooth
COLOR: black
SURFACE PROCESS: Paint all exposed surfaces
CLEARCOAT: Acrylic Polyurethane Clear Satin
FASTENER: Mechanically tightened around pole Contractor to
provide rubber gaskets were base and pole meet for tight fit.
NOTE: Include manufacturer approved aluminum skirt, as
needed to conceal footer. Skirt to be contin. welded to decorative base and painted to match decorative base.

4. SLEEVE

MATERIAL: 1/4" thk Aluminum
FABRICATION PROCESS: Extruded
EDGES: Square
COLOR: custom, as noted
SURFACE PROCESS: Paint all exposed surfaces
CLEARCOAT: Acrylic Polyurethane Clear Satin
FASTENER: Mechanically fastened to pole

30. BREAKAWAY FOOTER

Male/Female Coupling assembly. Base Plate welded to pole. Size and specs to be determined by Contractors structural engineer. As per NCDOT Division 9 Breakaway specifications

31 RISER


Custom Fabricated Aluminum Riser Piece to cover NCDOT Footer. 1/4" wall thickness Paint to Match Wrap around base and Pole Dia. to Match Width/Dia of Decorative Base and/or footer base plate.

DESIGN NOTE:

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SPECIFICATIONS SIGN TYPE: PARK.10 FUNCTION: Parking Identification

| 1. P

POLE: 5" dia. 1/4" thick aluminum
MATERIAL: Aluminum
FABRICATION PROCESS: Extruded
EDGES: Smooth
COLOR: custom as noted
SURFACE PROCESS: Paint all exposed surfaces
CLEARCOAT: Acrylic Polyurethane Clear Satin
FOOTER: As per NCDOT Division 9 Breakaway specifications

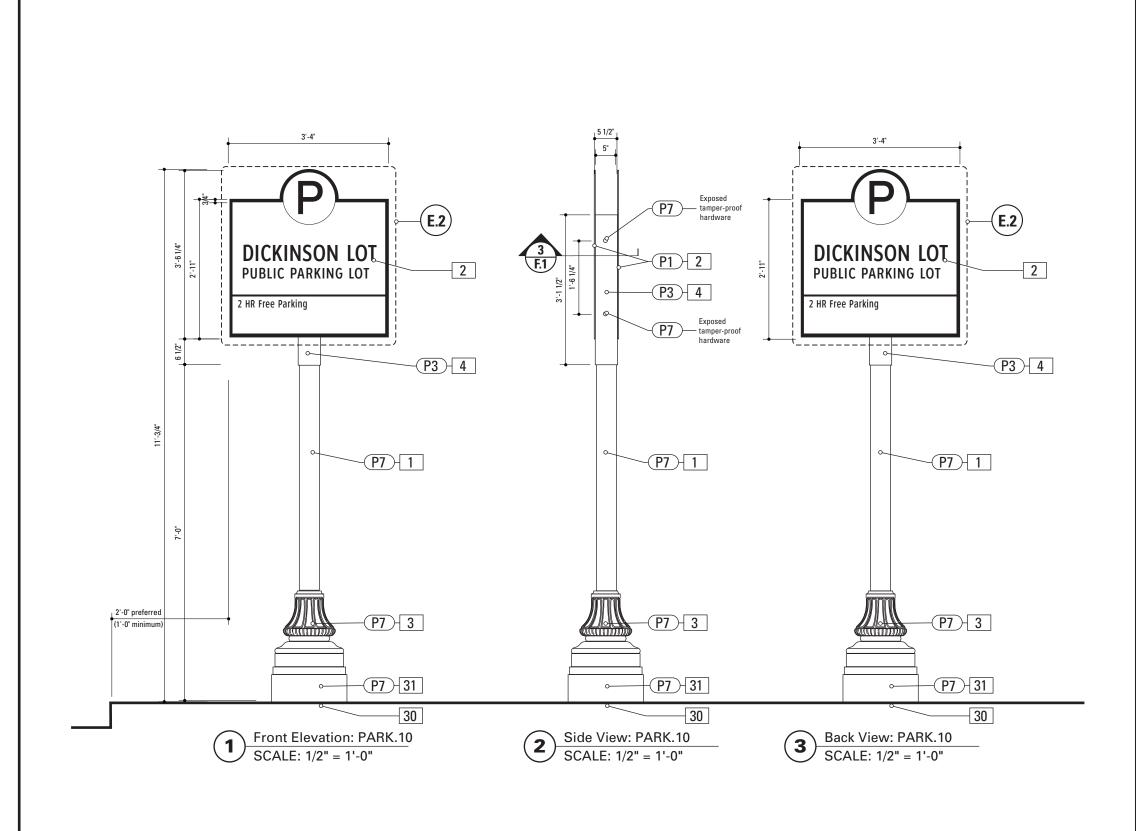2. SIGN PANEL

MATERIAL: 1/4" thk Aluminum
FABRICATION PROCESS: Square Cut
EDGES: Square
COLOR: custom, as noted
SURFACE PROCESS: Paint all exposed surfaces
CLEARCOAT: Acrylic Polyurethane Clear Satin
FASTENER: Mechanically fasten to backer panel

Reflective Vinyl Graphics applied to front face of Sign Panel. See Color Page for Specifications.

3. DECORATIVE BASE DESIGN: Wrap around 2 piece base. Mechanically tightened.

MATERIAL: Aluminum
FABRICATION PROCESS: Cast
EDGES: Smooth
COLOR: black
SURFACE PROCESS: Paint all exposed surfaces
CLEARCOAT: Acrylic Polyurethane Clear Satin
FASTENER: Mechanically tightened around pole Contractor to
provide rubber gaskets were base and pole meet for tight fit.
NOTE: Include manufacturer approved aluminum skirt, as
needed to conceal footer. Skirt to be contin. welded to decorative base and painted to match decorative base.

4. SLEEVE

MATERIAL: 1/4" thk Aluminum
FABRICATION PROCESS: Extruded
EDGES: Square
COLOR: custom, as noted
SURFACE PROCESS: Paint all exposed surfaces
CLEARCOAT: Acrylic Polyurethane Clear Satin
FASTENER: Mechanically fastened to pole

30. BREAKAWAY FOOTER

Male/Female Coupling assembly.
Base Plate welded to pole.
Size and specs to be determined by Contractors structural engineer. As per NCDOT Division 9 Breakaway specifications

31 RISER


Custom Fabricated Aluminum Riser Piece to cover NCDOT Footer. 1/4" wall thickness Paint to Match Wrap around base and Pole Dia. to Match Width/Dia of Decorative Base and/or footer base plate.

DESIGN NOTE:

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- 2. Welds: All welds shall be ground smooth, paint all seams.



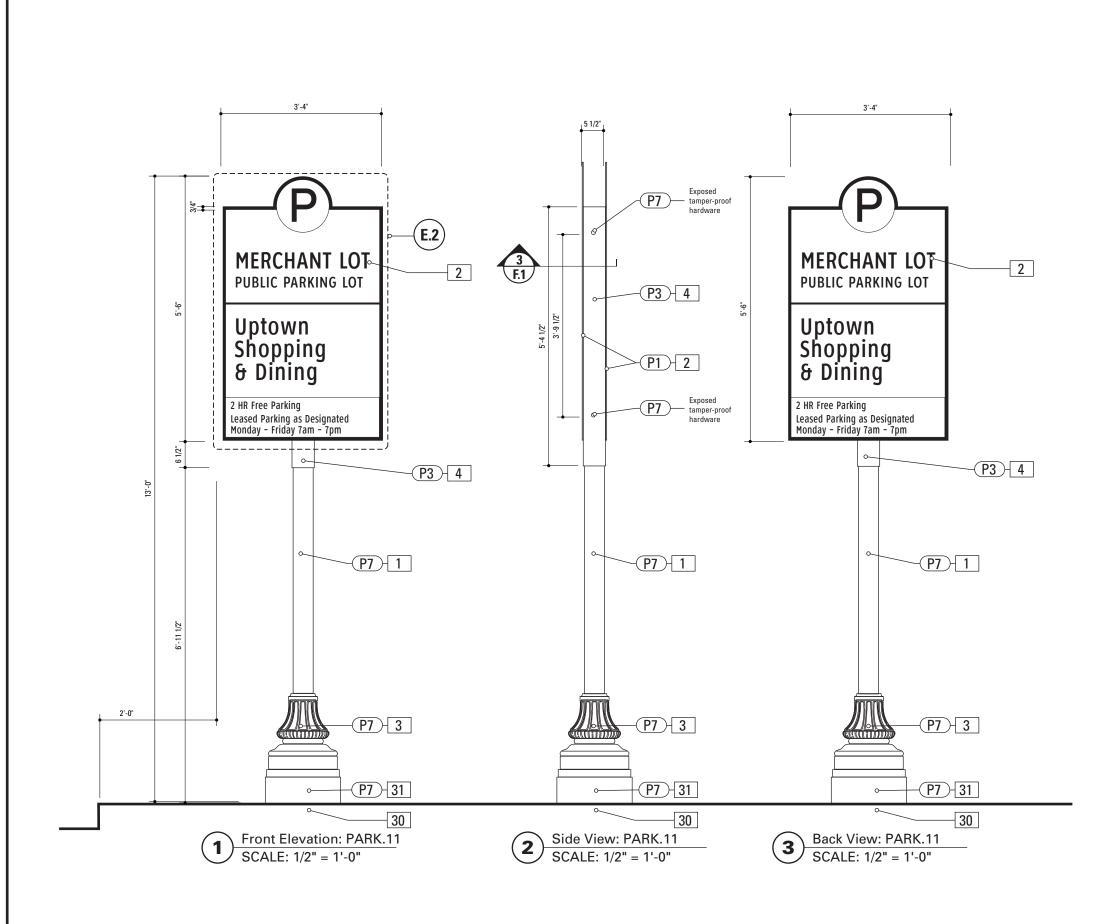

SPECIFICATIONS SIGN TYPE: PARK.11 FUNCTION: Parking Directional

1. P

POLE: 5" dia. 1/4" thick aluminum
MATERIAL: Aluminum
FABRICATION PROCESS: Extruded
EDGES: Smooth
COLOR: custom as noted
SURFACE PROCESS: Paint all exposed surfaces
CLEARCOAT: Acrylic Polyurethane Clear Satin
FOOTER: As per NCDOT Division 9 Breakaway specifications

2. SIGN PANEL

MATERIAL: 1/4" thk Aluminum
FABRICATION PROCESS: Square Cut
EDGES: Square
COLOR: custom, as noted
SURFACE PROCESS: Paint all exposed surfaces
CLEARCOAT: Acrylic Polyurethane Clear Satin
FASTENER: Mechanically fasten to backer panel

Reflective Vinyl Graphics applied to front face of Sign Panel. See Color Page for Specifications.

3. DECORATIVE BASE DESIGN: Wrap around 2 piece base. Mechanically tightened.

MATERIAL: Aluminum
FABRICATION PROCESS: Cast
EDGES: Smooth
COLOR: black
SURFACE PROCESS: Paint all exposed surfaces
CLEARCOAT: Acrylic Polyurethane Clear Satin
FASTENER: Mechanically tightened around pole Contractor to
provide rubber gaskets were base and pole meet for tight fit.
NOTE: Include manufacturer approved aluminum skirt, as
needed to conceal footer. Skirt to be contin. welded to decorative base and painted to match decorative base.

4. SLEEVE

MATERIAL: 1/4" thk Aluminum
FABRICATION PROCESS: Extruded
EDGES: Square
COLOR: custom, as noted
SURFACE PROCESS: Paint all exposed surfaces
CLEARCOAT: Acrylic Polyurethane Clear Satin
FASTEMER: Mechanically fastened to pole

30. BREAKAWAY FOOTER

Male/Female Coupling assembly.
Base Plate welded to pole.
Size and specs to be determined by Contractors structural engineer. As per NCDOT Division 9 Breakaway specifications

1 RISER

Custom Fabricated Aluminum Riser Piece to cover NCDOT Footer. 1/4" wall thickness Paint to Match Wrap around base and Pole Dia. to Match Width/Dia of Decorative Base and/or footer base plate.

DESIGN NOTE:


Final design and shop drawings shall be supplied by the fabricator. North Carolina registered professional engineer is required to sign and seal the submittal of shop drawings.

IOTES

by legal department.

- Fabricator shall verify the mounting conditions and provide a detail drawing for each mounting situation, prior to fabrication. Fabricator shall obtain approval from the Designer or Client for placement prior to fabrication.
- 2. Welds: All welds shall be ground smooth, paint all seams.

CLIENT / PROJECT ENVIRONMENTS & EXPERIENCES Clty of Greenville, NC 120 North Church Street City of Greenville, NC Suite 208 merje Wayfinding and Signage West Chester, PA 19380 T 484.266.0648 www.merjedesign.com PROJECT NO. Y41-07963 SHEET TITLE SUBCONSULTANT DRAWN BY: KB 6/30/2009 Sign Type PARK.11 These drawings are meant for DESIGN INTENT ONLY REVISIONS Parking Identification and are not for construction. Contractor shall verify and be responsible for all dimensions and conditio of the job. Contractor shall be familiar with the site 5/22/2010 and conditions it presents. This office must be noti-SHEET NO. fied of any variations from the dimensions and cond tions shown on this drawing. Shop drawings and details must be submitted to this office for approval D.19 prior to proceeding with fabrication. All copy shall be proofread by client and legal requirements checked

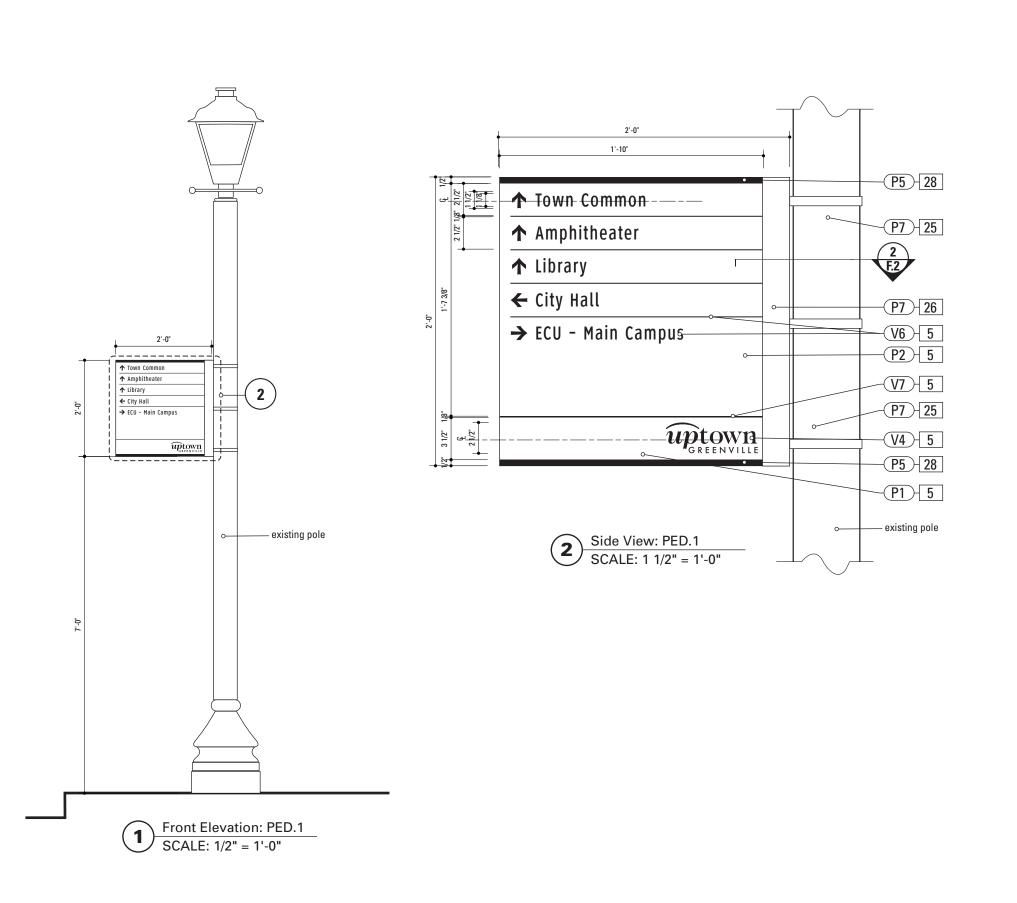

SPECIFICATIONS SIGN TYPE: PED.1 FUNCTION: Pedestrian Directional

5. SIGN PANEL

MATERIAL: 1/4" thk Aluminum FABRICATION PROCESS: Square Cut EDGES: Square COLOR: custom, as noted SURFACE PROCESS: Paint all exposed surfaces CLEARCOAT: Acrylic Polyurethane Clear Satin FASTENER: Mechanically fastened to U-Channel

Vinyl Graphics applied to front face of Sign Panel. See Color Page for Specifications.

MATERIAL: Stainless steel with threaded tightening assembly including hardware MOUNTING: Adjustable for utility and street poles (round square up to 10" dia.) COLOR: Painted to match existing pole QUANTITY: 3 per sign HARDWARE: As required - located on panel not interfere with graphic sign elements.

26. U-CHANNEL

MATERIAL: 1/4" thk Aluminum U-Channels FABRICATION PROCESS: Extruded EDGES: square COLOR: custom, as noted SURFACE PROCESS: Paint all exposed surfaces CLEARCOAT: Acrylic Polyurethane Clear Satin FASTENER: Mechanically fastened to Strap


28. ACCENT BAR
MATERIAL: 1/4" thick Aluminum bar stock
FABRICATION PROCESS: Extruded / Cut
EDGES: Square COLOR: custom, as noted SURFACE PROCESS: Paint all exposed surfaces CLEARCOAT: Acrylic Polyurethane Clear Satin FASTENER: mechanically fasten to sign panel


DESIGN NOTE:

Final design and shop drawings shall be supplied by the fabricator. North Carolina registered professional engineer is required to sign and seal the submittal of shop drawings.

- 1. Fabricator shall verify the mounting conditions and provide a detail drawing for each mounting situation, prior to fabrication. Fabricator shall obtain approval from the Designer or Client for placement prior to fabri-
- 2. Welds: All welds shall be ground smooth, paint all seams.

EXPERIENCES	CLIENT / PROJECT
120 North Church Street Suite 208 West Chester, PA 19380 T 484.266.0648	CIty of Greenville, NC City of Greenville, NC Wayfinding and Signage
www.merjedesign.com	PROJECT NO. Y41-07963
	SHEET TITLE
DRAWN BY: KB	Sign Type PED.1
REVISIONS	Pedestrian Directional
5/22/2010	
	SHEET NO.
	D.20
	120 North Church Street Suite 208 West Chester, PA 19380 T 484.266.0648 www.merjedesign.com DRAWN BY: KB REVISIONS

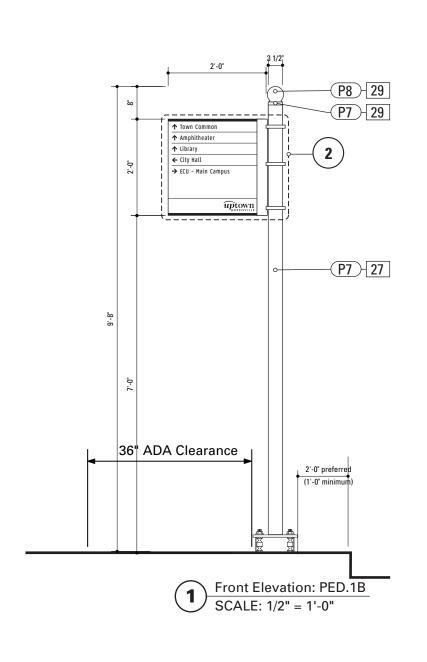

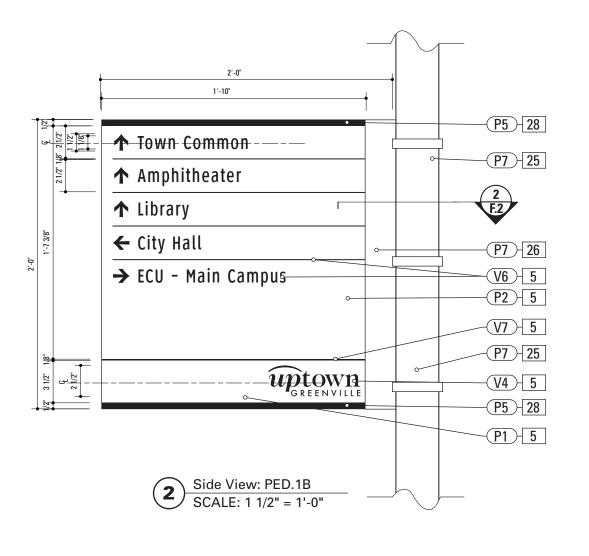

SPECIFICATIONS SIGN TYPE: PED.1B FUNCTION: Pedestrian Directional

5. SIGN PANEL

MATERIAL: 1/4" thk Aluminum
FABRICATION PROCESS: Square Cut
EDGES: Square
COLOR: custom, as noted
SURFACE PROCESS: Paint all exposed surfaces
CLEARCOAT: Acrylic Polyurethane Clear Satin
FASTENER: Mechanically fastened to U-Channel

Vinyl Graphics applied to front face of Sign Panel. See Color Page for Specifications.

25. STRAP

MATERIAL: Stainless steel with threaded tightening assembly including hardware MOUNTING: Adjustable for utility and street poles (round square up to 10" dia.)
COLOR: Painted to match existing pole QUANTITY: 3 per sign HARDWARE: As required - located on panel not interfere with graphic sign elements.

26. U-CHANNEL

MATERIAL: 1/4" thk Aluminum U-Channels FABRICATION PROCESS: Extruded EDGES: square COLOR: custom, as noted SURFACE PROCESS: Paint all exposed surfaces CLEARCOAT: Acrylic Polyurethane Clear Satin FASTENER: Mechanically fastened to Strap

27. POLE

POLE: 3 1/2" dia. 1/4" thick aluminum
MATERIAL: Aluminum
FABRICATION PROCESS: Extruded
EDGES: Smooth
COLOR: custom as noted
SURFACE PROCESS: Paint all exposed surfaces
CLEARCOAT: Acrylic Polyurethane Clear Satin
FOOTER: As per NCDOT Division 9 Breakaway specifications

28. ACCENT BAR

MATERIAL: 1/4" thick Aluminum bar stock FABRICATION PROCESS: Extruded / Cut EDGES: Square COLOR: custom, as noted SURFACE PROCESS: Paint all exposed surfaces CLEARCOAT: Acrylic Polyurethane Clear Satin FASTENER: mechanically fasten to sign panel

29. PEDESTRIAN POLE CAP

PRODUCT: Cast Aluminum Post Top Finial MATERIAL: Aluminum FABRICATION PROCESS: Cast EDGES: Smooth COLOR: custom as noted

DESIGN NOTE:


SURFACE PROCESS: Paint all exposed surfaces

CLEARCOAT: Acrylic Polyurethane Clear Satin

Final design and shop drawings shall be supplied by the fabricator. North Carolina registered professional engineer is required to sign and seal the submittal of shop drawings.


- Fabricator shall verify the mounting conditions and provide a detail drawing for each mounting situation, prior to fabrication. Fabricator shall obtain approval from the Designer or Client for placement prior to fabrication.
- 2. Welds: All welds shall be ground smooth, paint all seams.

ENVIRONMENTS &	EXPERIENCES	CLIENT / PROJECT	
merje	120 North Church Street Suite 208 West Chester, PA 19380 T 484.266.0648	Clty of Greenville, NC City of Greenville, NC Wayfinding and Signage	
	www.merjedesign.com	PROJECT NO. Y41-07963	
JBCONSULTANT		SHEET TITLE	
ATE 6/30/2009	DRAWN BY: KB	Sign Type PED.1B	
ese drawings are meant for DESIGN INTENT ONLY d are not for construction. Contractor shall verify	REVISIONS	Pedestrian Directional	
d be responsible for all dimensions and conditions the job. Contractor shall be familiar with the site d conditions it presents. This office must be noti-	5/22/2010		
d of any variations from the dimensions and condi- ns shown on this drawing. Shop drawings and		SHEET NO.	
tails must be submitted to this office for approval or to proceeding with fabrication. All copy shall be nofread by client and legal requirements checked		D.21	

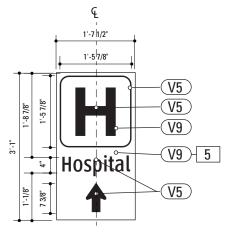

Alternate Graphic Layout: SERVICE.1

SCALE: 1/2" = 1'-0"

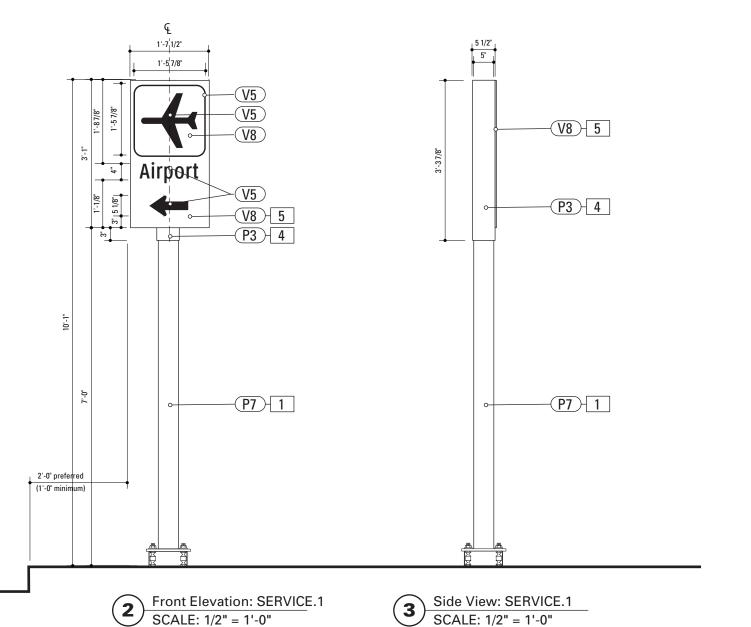

SPECIFICATIONS SIGN TYPE: SERVICE.1 FUNCTION: Service Trailblazer

POLE: 5" dia. 1/4" thick aluminum

MATERIAL: Aluminum
FABRICATION PROCESS: Extruded
EDGES: Smooth

COLOR: custom as noted SURFACE PROCESS: Paint all exposed surfaces CLEARCOAT: Acrylic Polyurethane Clear Satin FOOTER: As per NCDOT Division 9 Breakaway specifications

2. SIGN PANEL

MATERIAL: 1/4" thk Aluminum
FABRICATION PROCESS: Square Cut
EDGES: Square
COLOR: custom, as noted
SURFACE PROCESS: Paint all exposed surfaces
CLEARCOAT: Acrylic Polyurethane Clear Satin
FASTENER: Mechanically fasten to backer panel

Reflective Vinyl Graphics applied to front face of Sign Panel. See Color Page for Specifications.

4. SLEEVE

MATERIAL: 1/4" thk Aluminum
FABRICATION PROCESS: Extruded
EDGES: Square
COLOR: custom, as noted
SURFACE PROCESS: Paint all exposed surfaces
CLEARCOAT: Acrylic Polyurethane Clear Satin
FASTENER: Mechanically fastened to pole

30. BREAKAWAY FOOTER

Male/Female Coupling assembly. Base Plate welded to pole. Size and specs to be determined by Contractors structural engineer. As per NCDOT Division 9 Breakaway specifications


DESIGN NOTE:

Final design and shop drawings shall be supplied by the fabricator. North Carolina registered professional engineer is required to sign and seal the submittal of shop drawings.

NOTES

- Fabricator shall verify the mounting conditions and provide a detail drawing for each mounting situation, prior to fabrication. Fabricator shall obtain approval from the Designer or Client for placement prior to fabrication.
- 2. Welds: All welds shall be ground smooth, paint all seams.

CLIENT / PROJECT ENVIRONMENTS & EXPERIENCES Clty of Greenville, NC 120 North Church Street City of Greenville, NC Suite 208 Wayfinding and Signage West Chester, PA 19380 T 484.266.0648 www.merjedesign.com PROJECT NO. Y41-07963 SHEET TITLE SUBCONSULTANT DRAWN BY: KΒ 6/30/2009 Sign Type SERVICE.1 REVISIONS These drawings are meant for DESIGN INTENT ONLY Service Trailblazer and are not for construction. Contractor shall verify and be responsible for all dimensions and condition of the job. Contractor shall be familiar with the site 5/22/2010 and conditions it presents. This office must be noti-SHEET NO. fied of any variations from the dimensions and cond tions shown on this drawing. Shop drawings and details must be submitted to this office for approval **D.22** prior to proceeding with fabrication. All copy shall be proofread by client and legal requirements checked by legal department.

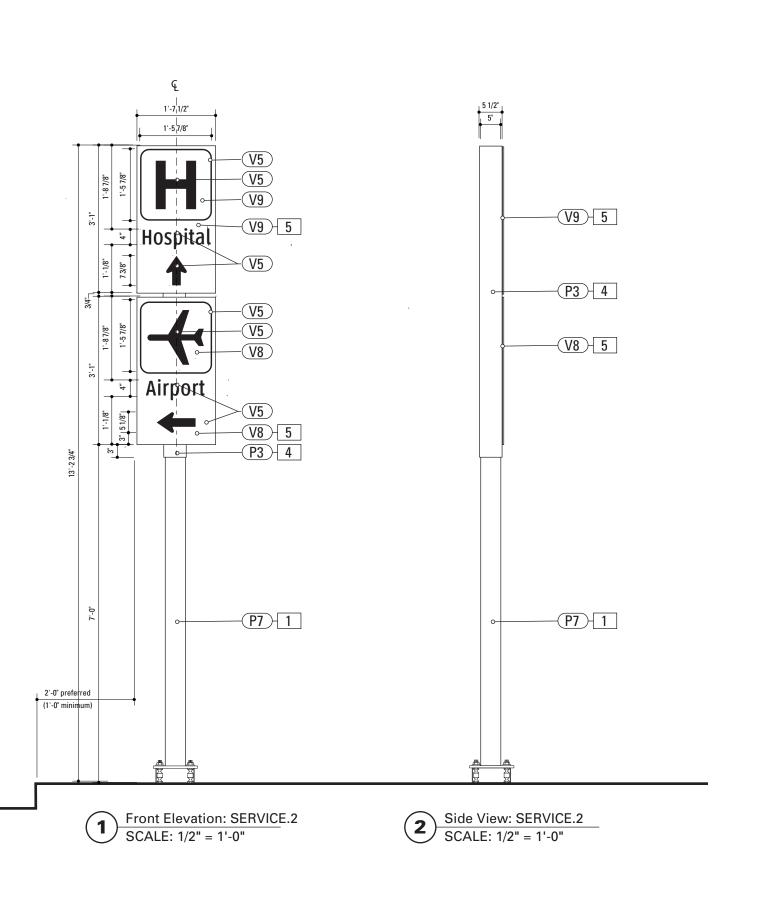

SPECIFICATIONS SIGN TYPE: SERVICE.2 FUNCTION: Service Trailblazer

POLE: 5" dia. 1/4" thick aluminum MATERIAL: Aluminum
FABRICATION PROCESS: Extruded EDGES: Smooth COLOR: custom as noted SURFACE PROCESS: Paint all exposed surfaces CLEARCOAT: Acrylic Polyurethane Clear Satin FOOTER: As per NCDOT Division 9 Breakaway specifications

2. SIGN PANEL MATERIAL: 1/4" thk Aluminum FABRICATION PROCESS: Square Cut EDGES: Square COLOR: custom, as noted SURFACE PROCESS: Paint all exposed surfaces CLEARCOAT: Acrylic Polyurethane Clear Satin FASTENER: Mechanically fasten to backer panel

Reflective Vinyl Graphics applied to front face of Sign Panel. See Color Page for Specifications.

4. SLEEVE

MATERIAL: 1/4" thk Aluminum FABRICATION PROCESS: Extruded EDGES: Square COLOR: custom, as noted
SURFACE PROCESS: Paint all exposed surfaces CLEARCOAT: Acrylic Polyurethane Clear Satin FASTENER: Mechanically fastened to pole

30. BREAKAWAY FOOTER


Male/Female Coupling assembly. Base Plate welded to pole. Size and specs to be determined by Contractors structural engineer. As per NCDOT Division 9 Breakaway specifications

DESIGN NOTE:

Final design and shop drawings shall be supplied by the fabricator. North Carolina registered professional engineer is required to sign and seal the submittal of shop drawings.

- 1. Fabricator shall verify the mounting conditions and provide a detail drawing for each mounting situation, prior to fabrication. Fabricator shall obtain approval from the Designer or Client for placement prior to fabri-
- 2. Welds: All welds shall be ground smooth, paint all seams.

ENVIRONMENTS &	EXPERIENCES	CLIENT / PROJECT	
merje	120 North Church Street Suite 208 West Chester, PA 19380 T 484.266.0648	CIty of Greenville, NC City of Greenville, NC Wayfinding and Signage	
	www.merjedesign.com	PROJECT NO. Y41-07963	
SUBCONSULTANT	SHEET TITLE		
DATE 6/30/2009 DRAWN BY: KB		Sign Type SERVICE.2	
These drawings are meant for DESIGN INTENT ONLY and are not for construction. Contractor shall verify	REVISIONS	Service Trailblazer	
and be responsible for all dimensions and conditions of the job. Contractor shall be familiar with the site and conditions it presents. This office must be noti-	5/22/2010		
fied of any variations from the dimensions and condi- tions shown on this drawing. Shop drawings and		SHEET NO.	
details must be submitted to this office for approval prior to proceeding with fabrication. All copy shall be proofread by client and legal requirements checked by legal department.		D.23	

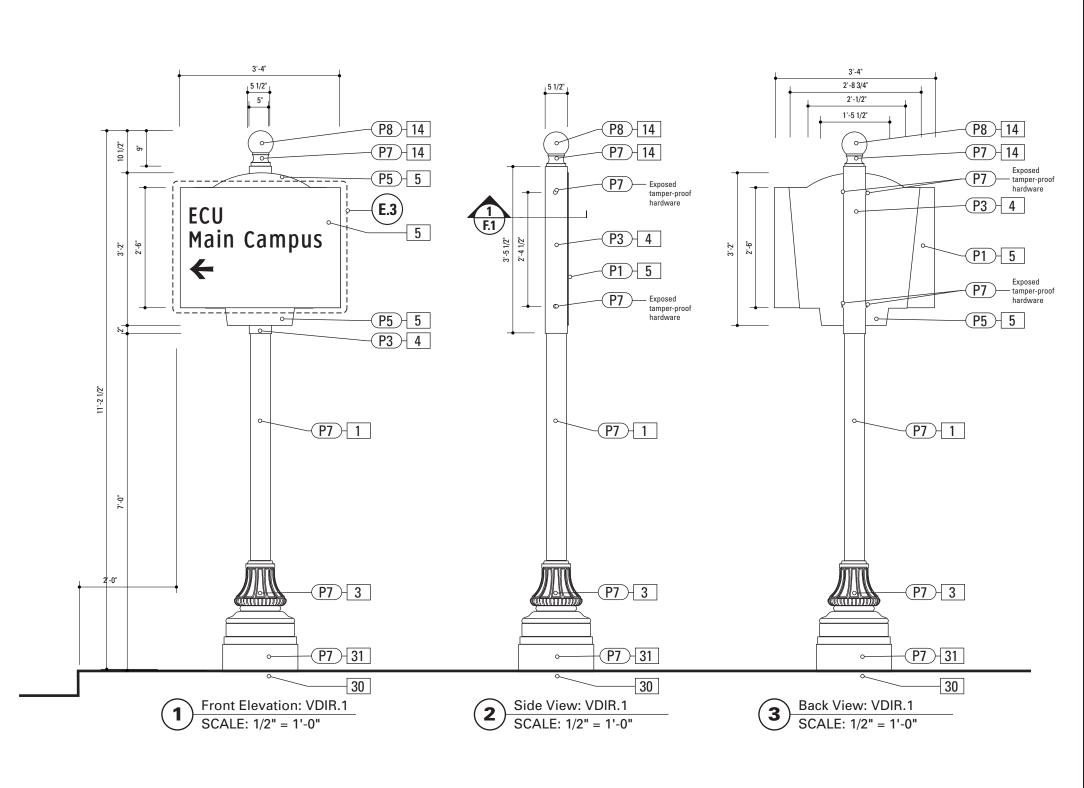

SPECIFICATIONS SIGN TYPE: VDIR.1 FUNCTION: Vehicular Directional

31 RISER

1. POLE POLE: 5" dia. 1/4" thick aluminum

MATERIAL: Aluminum
FABRICATION PROCESS: Extruded
EDGES: Smooth
COLOR: custom as noted
SURFACE PROCESS: Paint all exposed surfaces
CLEARCOAT: Acrylic Polyurethane Clear Satin
FOOTER: As per NCDOT Division 9 Breakaway specifications

3. DECORATIVE BASE

DESIGN: Wrap around 2 piece base. Mechanically tightened.
MATERIAL: Aluminum
FABRICATION PROCESS: Cast
EDGES: Smooth
COLOR: black
SURFACE PROCESS: Paint all exposed surfaces
CLEARCOAT: Acrylic Polyurethane Clear Satin
FASTENER: Mechanically tightened around pole Contractor to
provide rubber gaskets were base and pole meet for tight fit.
NOTE: Include manufacturer approved aluminum skirt, as
needed to conceal footer. Skirt to be contin. welded to decorative base and painted to match decorative base.

4. SLEEVE

MATERIAL: 1/4" thk Aluminum
FABRICATION PROCESS: Extruded
EDGES: Square
COLOR: custom, as noted
SURFACE PROCESS: Paint all exposed surfaces
CLEARCOAT: Acrylic Polyurethane Clear Satin
FASTENER: Mechanically fastened to pole

5. SIGN PANEL

MATERIAL: 1/4" thk Aluminum
FABRICATION PROCESS: Square Cut
EDGES: Square
COLOR: custom, as noted
SURFACE PROCESS: Paint all exposed surfaces
CLEARCOAT: Acrylic Polyurethane Clear Satin
FASTENER: Mechanically fasten to backer panel

Reflective Vinyl Graphics applied to front face of Sign Panel. See Color Page for Specifications.

14. POLE CAP

PRODUCT: Cast Aluminum Post Top Finial MATERIAL: Aluminum FABRICATION PROCESS: Cast EDGES: Smooth COLOR: custom as noted SURFACE Process: Paint all exposed surfaces CLEARCOAT: Acrylic Polyurethane Clear Satin FASTENER: Me

30. BREAKAWAY FOOTER

Male/Female Coupling assembly. Base Plate welded to pole. to cover NCDOT Footer.
1/4" wall thickness
Paint to Match Wrap around base and Pole
Dia. to Match Width/Dia of Decorative Base
and/or footer base plate.

Custom Fabricated Aluminum Riser Piece

Size and specs to be determined by Contractors structural


engineer. As per NCDOT Division 9 Breakaway specifications


DESIGN NOTE:

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- Fabricator shall verify the mounting conditions and provide a detail drawing for each mounting situation, prior to fabrication. Fabricator shall obtain approval from the Designer or Client for placement prior to fabrication.
- 2. Welds: All welds shall be ground smooth, paint all seams.

ENVIRONMENTS &	EXPERIENCES	CLIENT / PROJECT	
merje	120 North Church Street Suite 208 West Chester, PA 19380 T 484.266.0648	CIty of Greenville, NC City of Greenville, NC Wayfinding and Signage	
	www.merjedesign.com	PROJECT NO. Y41-07963	
SUBCONSULTANT		SHEET TITLE	
DATE _ ,	DRAWN BY:	Sian Type VDIR.1	
6/30/2009	KB	Sian Type VDIR.1	
These drawings are meant for DESIGN INTENT ONLY and are not for construction. Contractor shall verify	REVISIONS	Sign Type VDIR.1 Vehicular Directional	
These drawings are meant for DESIGN INTENT ONLY and are not for construction. Contractor shall verify and be responsible for all dimensions and conditions of the job. Contractor shall be familiar with the site	KB	Vehicular Directional	
These drawings are meant for DESIGN INTENT ONLY and are not for construction. Contractor shall verify and be responsible for all dimensions and conditions of the job. Contractor shall be familiar with the site and conditions it presents. This office must be notified of any variations from the dimensions and conditions shown on this drawing. Shop drawings and	REVISIONS KB	, ,,	
These drawings are meant for DESIGN INTENT ONLY and are not for construction. Contractor shall verify and be responsible for all dimensions and conditions of the job. Contractor shall be familiar with the site and conditions it presents. This office must be notified of any variations from the dimensions and conditions.	REVISIONS KB	Vehicular Directional	



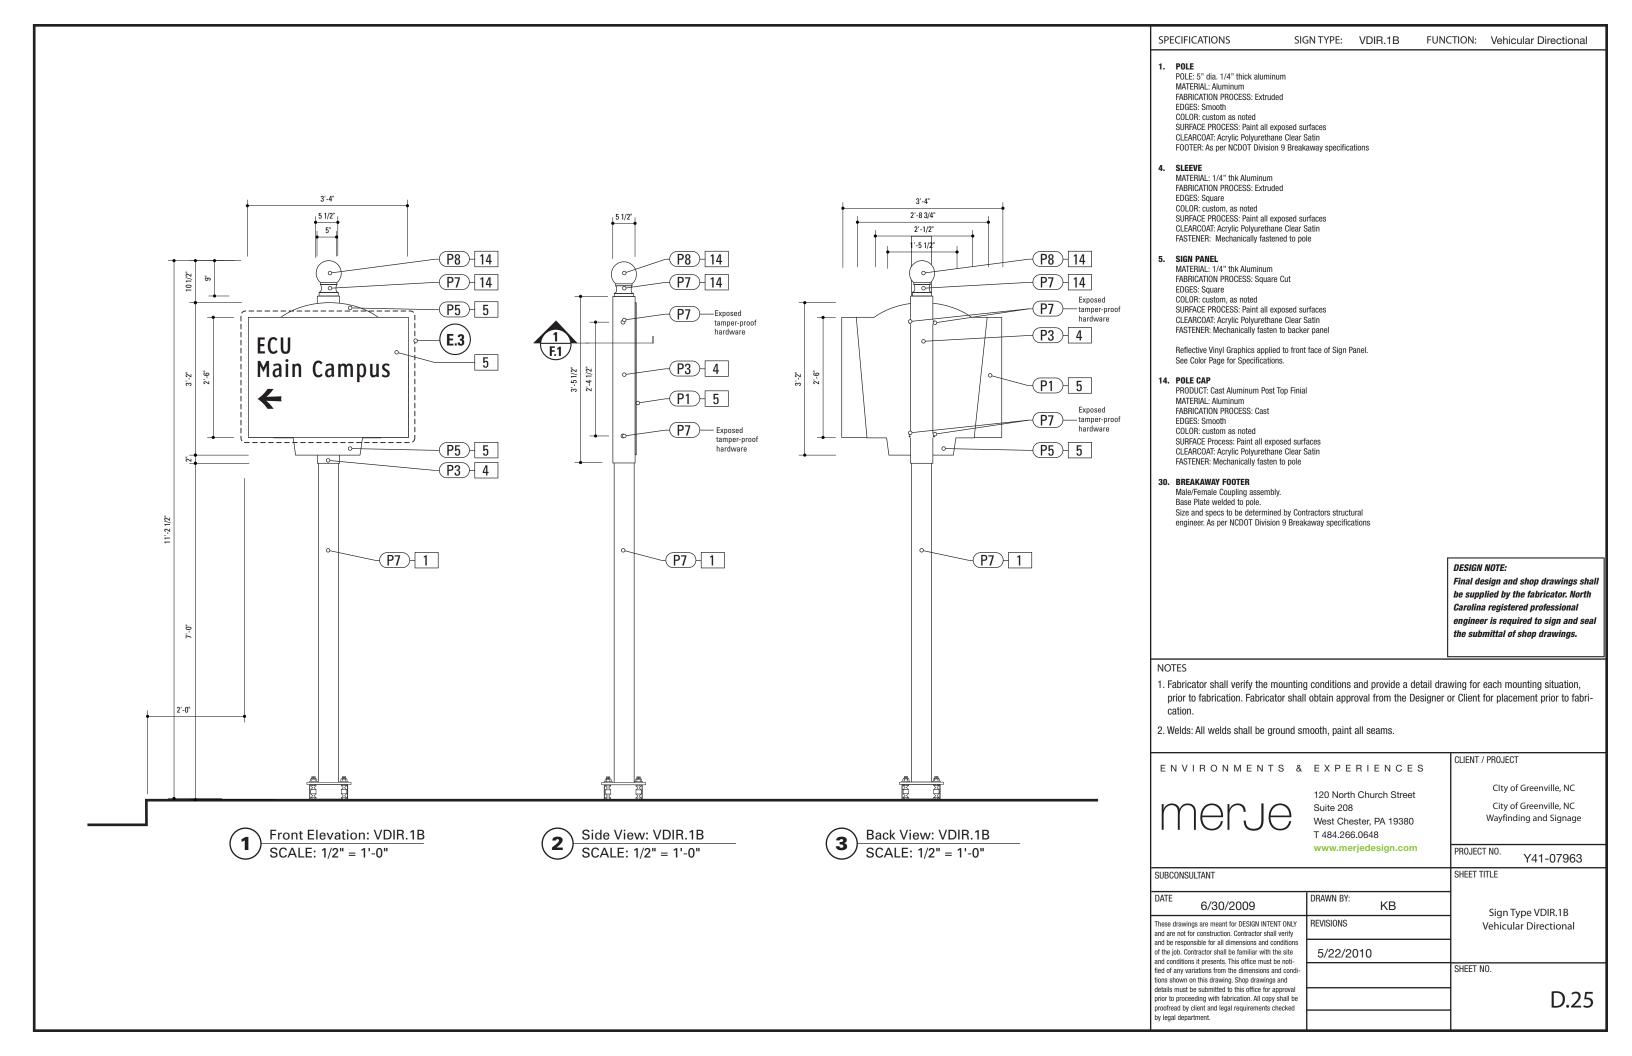

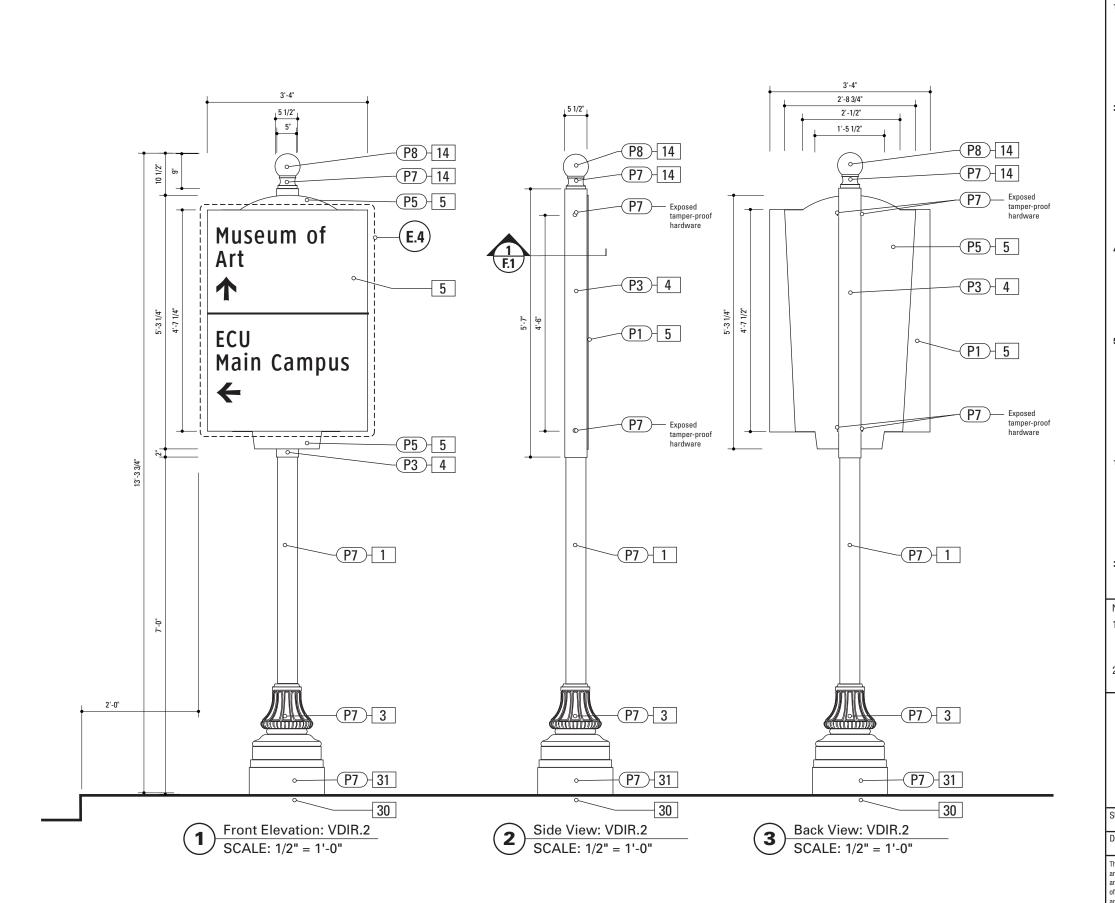SPECIFICATIONS SIGN TYPE: VDIR.2 FUNCTION: Vehicular Directional

1. POLE POLE: 5" dia. 1/4" thick aluminum

MATERIAL: Aluminum
FABRICATION PROCESS: Extruded
EDGES: Smooth
COLOR: custom as noted
SURFACE PROCESS: Paint all exposed surfaces
CLEARCOAT: Acrylic Polyurethane Clear Satin
FOOTER: As per NCDOT Division 9 Breakaway specifications

3. DECORATIVE BASE

DESIGN: Wrap around 2 piece base. Mechanically tightened.
MATERIAL: Aluminum
FABRICATION PROCESS: Cast
EDGES: Smooth
COLOR: black
SURFACE PROCESS: Paint all exposed surfaces
CLEARCOAT: Acrylic Polyurethane Clear Satin
FASTENER: Mechanically tightened around pole Contractor to
provide rubber gaskets were base and pole meet for tight fit.
NOTE: include manufacturer approved aluminum skirt, as
needed to conceal footer. Skirt to be contin. welded to decorative base and painted to match decorative base.

4. SLEEVE

MATERIAL: 1/4" thk Aluminum
FABRICATION PROCESS: Extruded
EDGES: Square
COLOR: custom, as noted
SURFACE PROCESS: Paint all exposed surfaces
CLEARCOAT: Acrylic Polyurethane Clear Satin
FASTENER: Mechanically fastened to pole

5. SIGN PANEL

MATERIAL: 1/4" thk Aluminum
FABRICATION PROCESS: Square Cut
EDGES: Square
COLOR: custom, as noted
SURFACE PROCESS: Paint all exposed surfaces
CLEARCOAT: Acrylic Polyurethane Clear Satin
FASTENER: Mechanically fasten to backer panel

Reflective Vinyl Graphics applied to front face of Sign Panel. See Color Page for Specifications.

14. POLE CAP

PRODUCT: Cast Aluminum Post Top Finial
MATERIAL: Aluminum
FABRICATION PROCESS: Cast
EDGES: Smooth
COLOR: custom as noted
SURFACE Process: Paint all exposed surfaces
CLEARCOAT: Acrylic Polyurethane Clear Satin
FASTENER: Mechanically fasten to pole

30. BREAKAWAY FOOTER

Male/Female Coupling assembly.
Base Plate welded to pole.

31 RISER

to cover NCDOT Footer.
1/4" wall thickness
Paint to Match Wrap around base and Pole
Dia. to Match Width/Dia of Decorative Base
and/or footer base plate.

Custom Fabricated Aluminum Riser Piece

Size and specs to be determined by Contractors structural

engineer. As per NCDOT Division 9 Breakaway specifications


DESIGN NOTE:


Final design and shop drawings shall be supplied by the fabricator. North Carolina registered professional engineer is required to sign and seal the submittal of shop drawings.


OTES


- Fabricator shall verify the mounting conditions and provide a detail drawing for each mounting situation, prior to fabrication. Fabricator shall obtain approval from the Designer or Client for placement prior to fabrication.
- 2. Welds: All welds shall be ground smooth, paint all seams.

ENVIRONMENTS &	EXPERIENCES	CLIENT / PROJECT
merje	120 North Church Street Suite 208 West Chester, PA 19380 T 484.266.0648	CIty of Greenville, NC City of Greenville, NC Wayfinding and Signage
	www.merjedesign.com	PROJECT NO. Y41-07963
UBCONSULTANT		SHEET TITLE
ATE 6/30/2009	DRAWN BY: KB	Sign Type VDIR.2
nese drawings are meant for DESIGN INTENT ONLY and are not for construction. Contractor shall verify	REVISIONS	Vehicular Directional
nd be responsible for all dimensions and conditions the job. Contractor shall be familiar with the site and conditions it presents. This office must be noti-	5/22/2010	
ed of any variations from the dimensions and condi-		SHEET NO.
ons shown on this drawing. Shop drawings and		

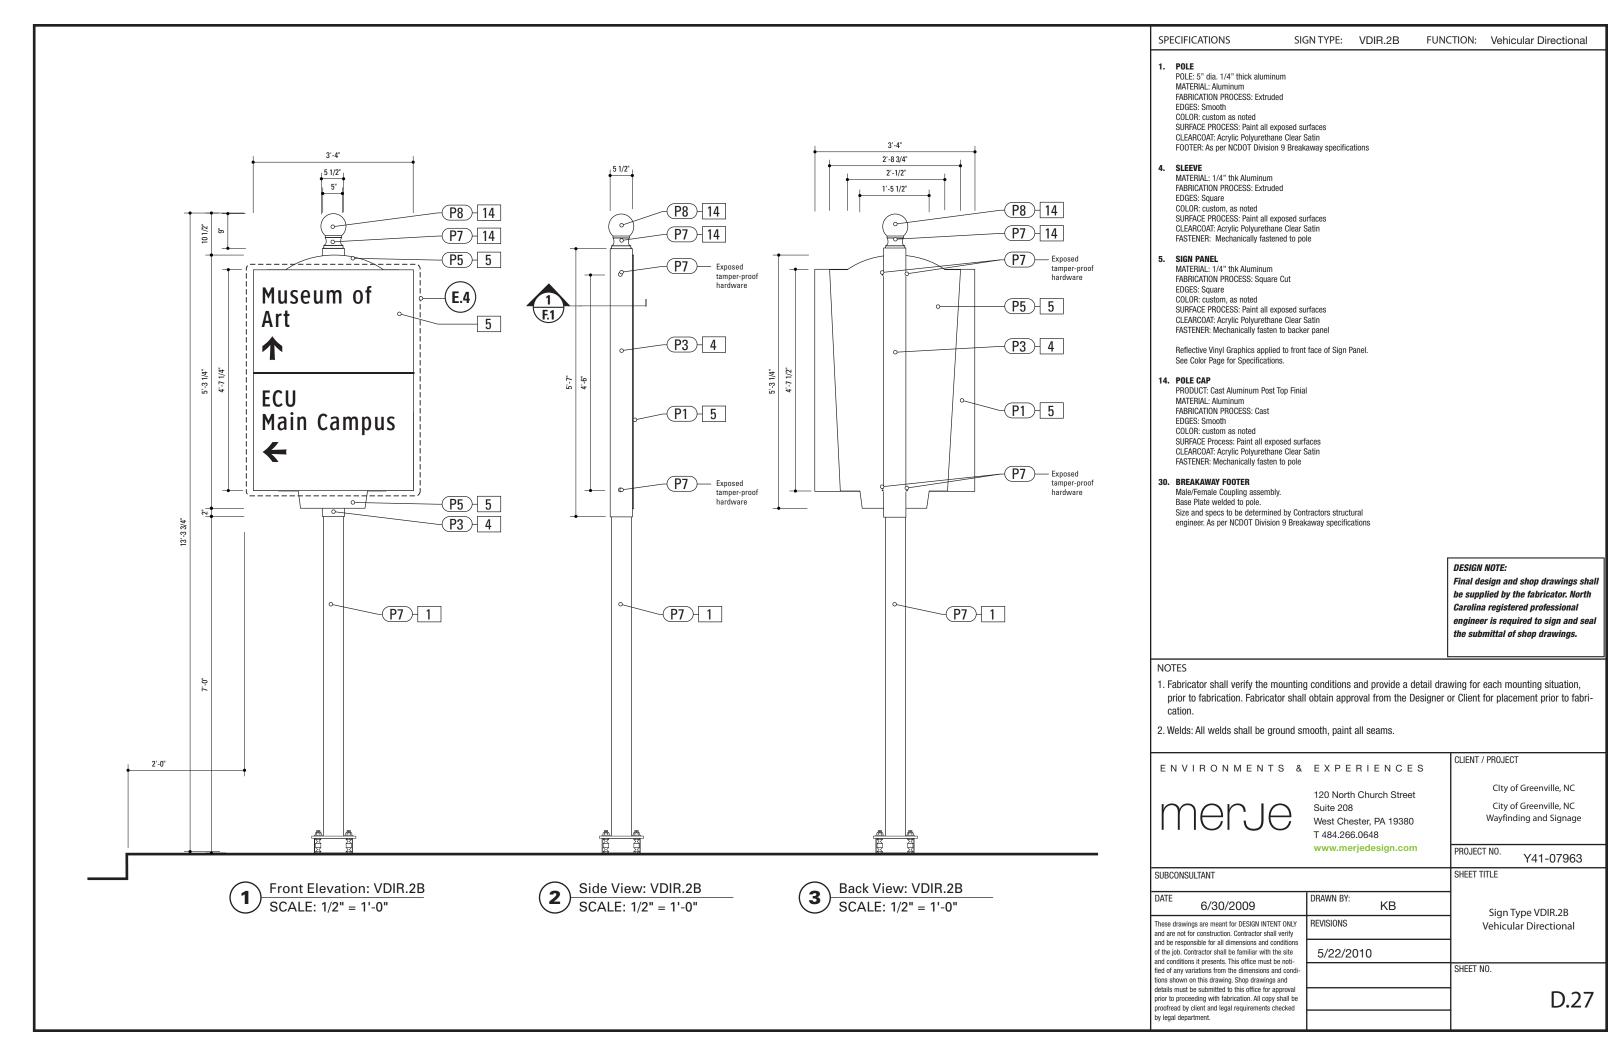


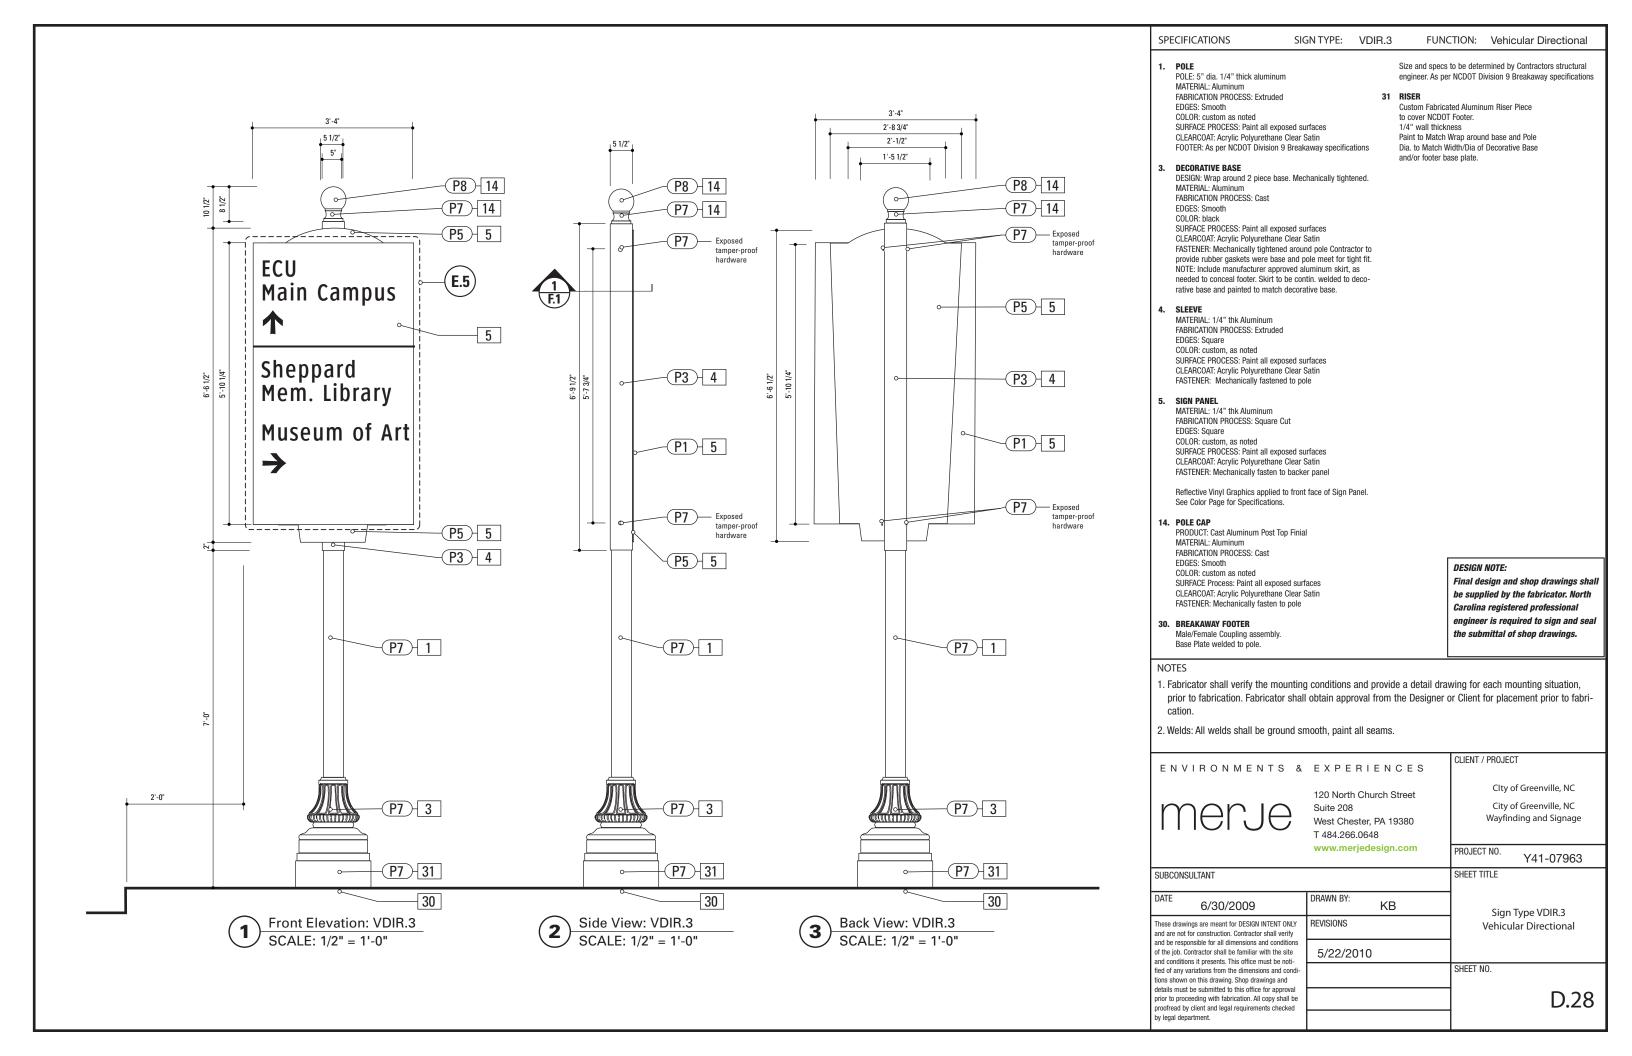


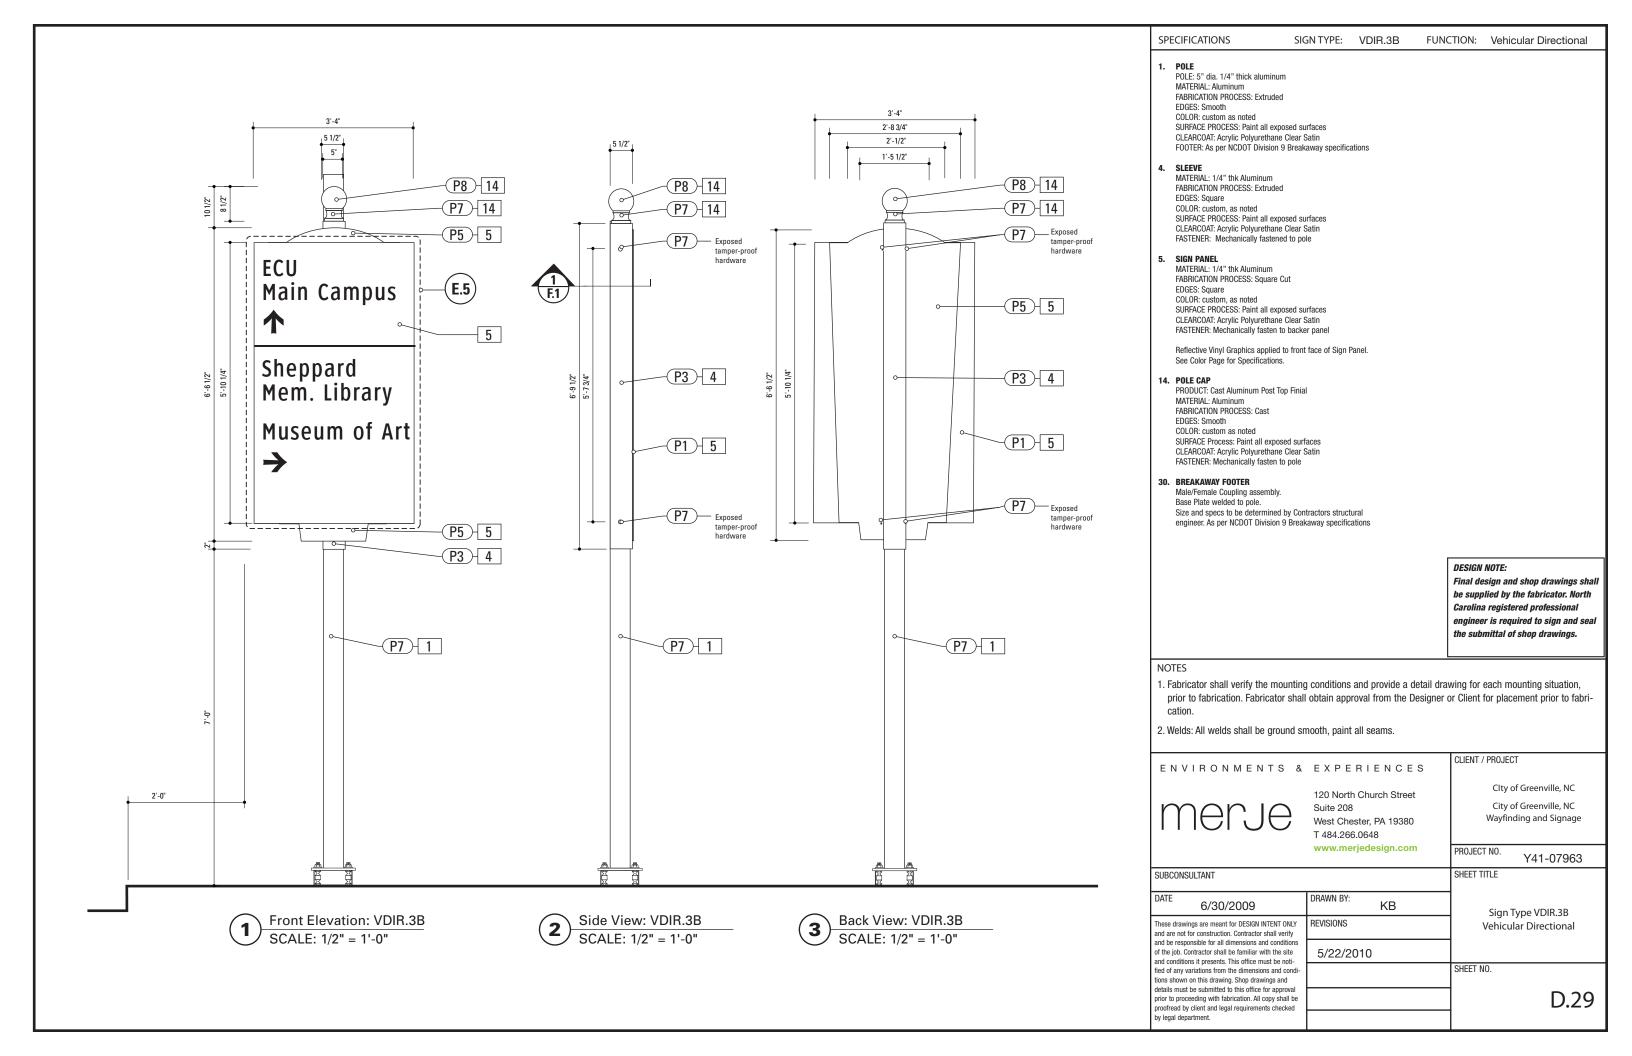

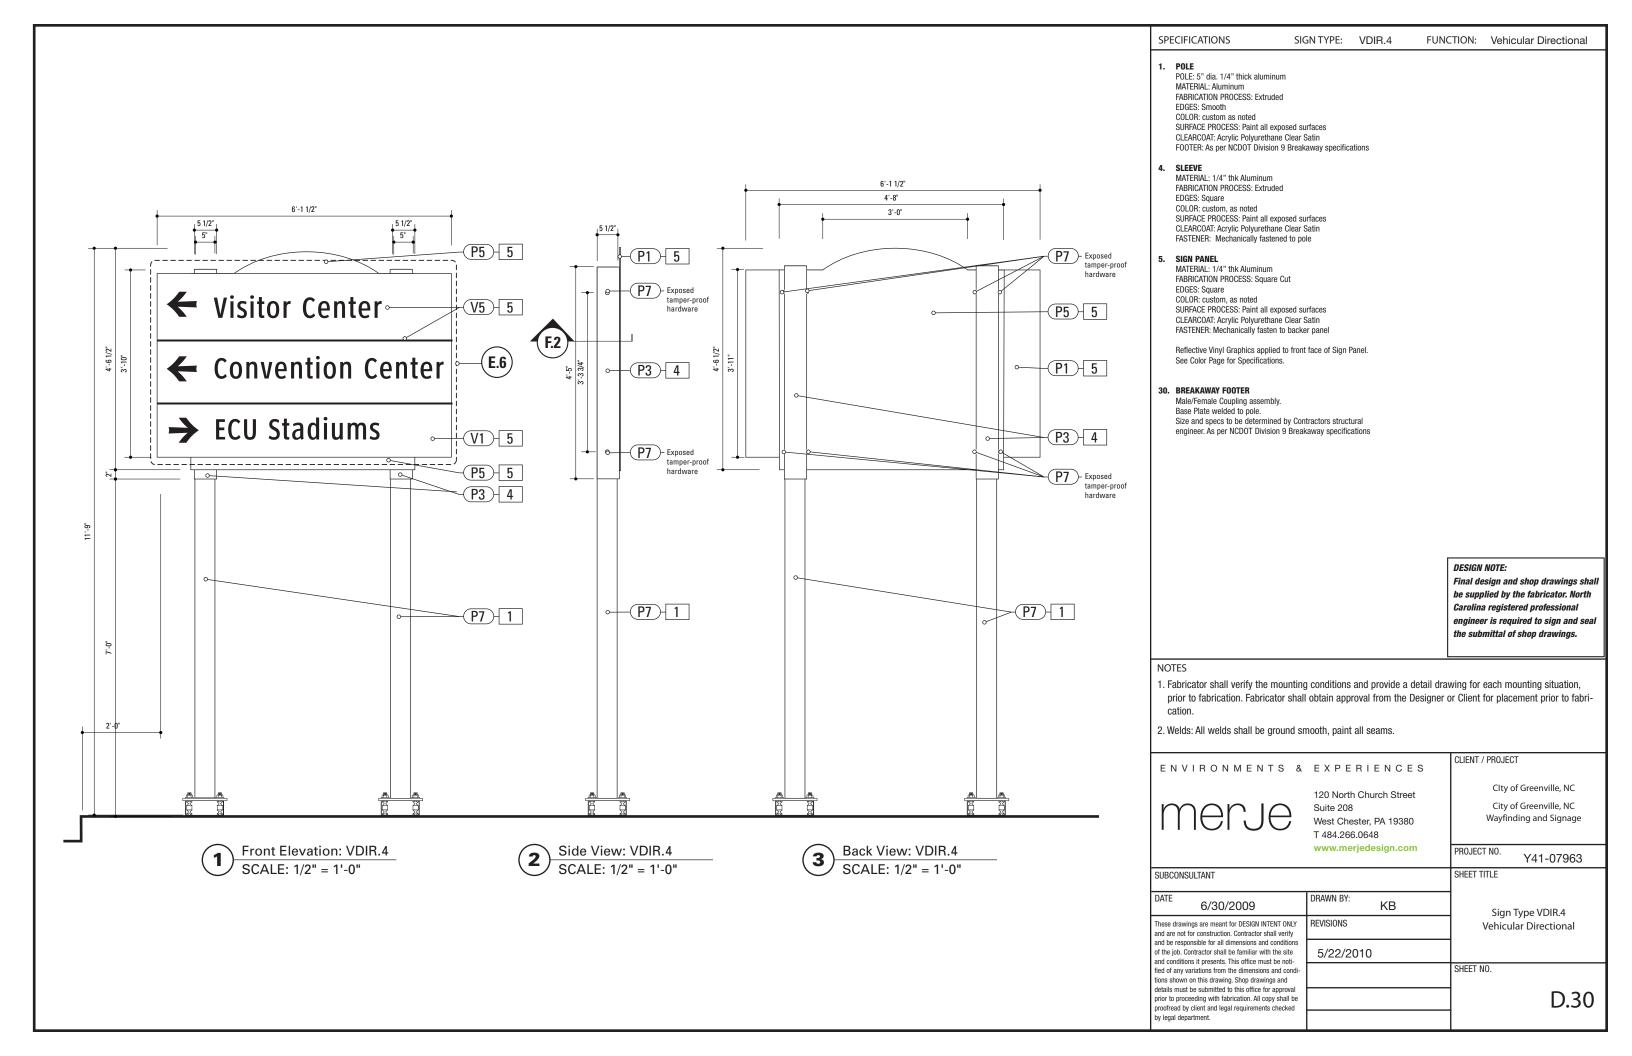

E. Graphic Layouts

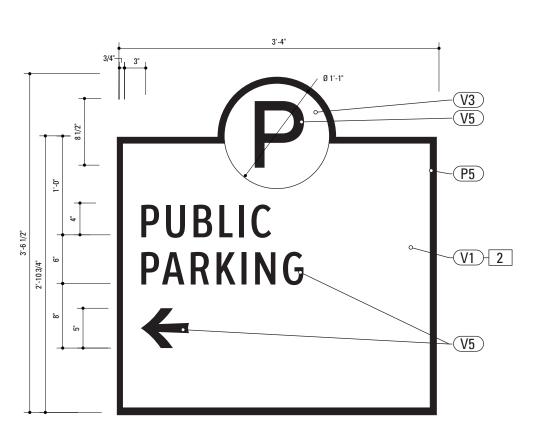

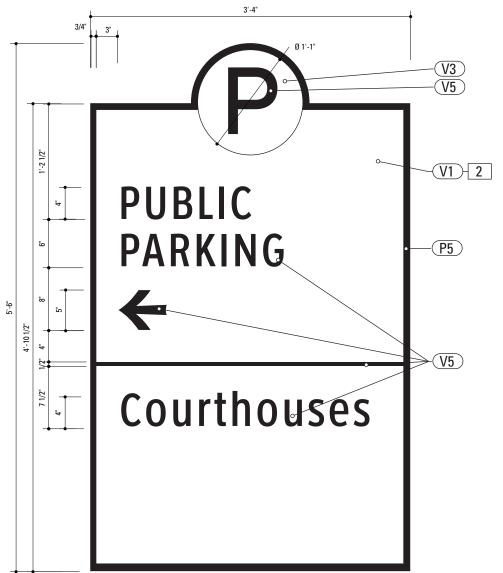

Graphic Layout: PARK.3 SCALE: 1" = 1'-0"

Graphic Layout: PARK.4 SCALE: 1" = 1'-0"

SPECIFICATIONS SIGN TYPE: PARK.3-4 FUNCTION: Parking Directional

2. SIGN PANEL

MATERIAL: 1/4" thk Aluminum FABRICATION PROCESS: Router Cut EDGES: Smooth COLOR: custom, as noted SURFACE PROCESS: Paint all exposed surfaces CLEARCOAT: Acrylic Polyurethane Clear Satin FASTENER: Mechanically fastened to sleeve

Reflective Vinyl Graphics applied to front face of Sign Panel. See Color Page for Specifications.

Final design and shop drawings shall be supplied by the fabricator. North Carolina registered professional engineer is required to sign and seal the submittal of shop drawings.


- 1. Fabricator shall verify the mounting conditions and provide a detail drawing for each mounting situation, prior to fabrication. Fabricator shall obtain approval from the Designer or Client for placement prior to fabri-
- 2. Welds: All welds shall be ground smooth, paint all seams.

proofread by client and legal requirements checked

by legal department.

CLIENT / PROJECT ENVIRONMENTS & EXPERIENCES CIty of Greenville, NC 120 North Church Street City of Greenville, NC Suite 208 Wayfinding and Signage West Chester, PA 19380 T 484.266.0648 www.merjedesign.com PROJECT NO. Y41-07963 SHEET TITLE SUBCONSULTANT DRAWN BY: 6/30/2009 KΒ Sign Type PARK.3-4 These drawings are meant for DESIGN INTENT ONLY Parking Directional and are not for construction. Contractor shall verify and be responsible for all dimensions and condition of the job. Contractor shall be familiar with the site 5/22/2010 and conditions it presents. This office must be notified of any variations from the dimensions and cond tions shown on this drawing. Shop drawings and details must be submitted to this office for approval E.1 prior to proceeding with fabrication. All copy shall be



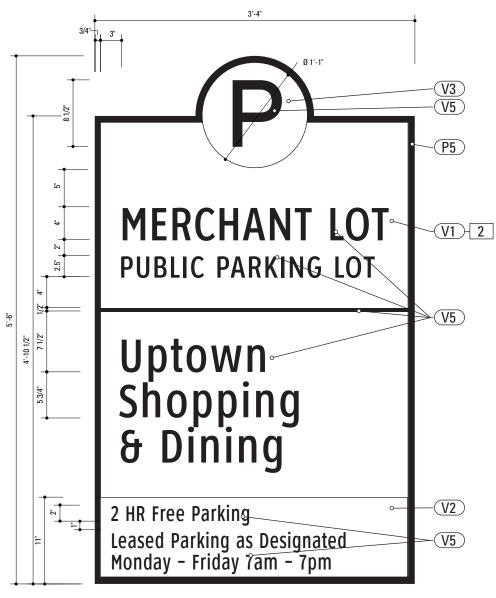

Graphic Layout: PARK.10

SCALE: 1" = 1'-0"

Graphic Layout: PARK.11
SCALE: 1" = 1'-0"


SIGN TYPE: PARK.10-11 FUNCTION: Parking Identification **SPECIFICATIONS** 2. SIGN PANEL MATERIAL: 1/4" thk Aluminum FABRICATION PROCESS: Router Cut EDGES: Smooth COLOR: custom, as noted SURFACE PROCESS: Paint all exposed surfaces CLEARCOAT: Acrylic Polyurethane Clear Satin FASTENER: Mechanically fastened to sleeve Reflective Vinyl Graphics applied to front face of Sign Panel. See Color Page for Specifications. **DESIGN NOTE:** Final design and shop drawings shall be supplied by the fabricator. North Carolina registered professional engineer is required to sign and seal the submittal of shop drawings. 1. Fabricator shall verify the mounting conditions and provide a detail drawing for each mounting situation, prior to fabrication. Fabricator shall obtain approval from the Designer or Client for placement prior to fabri-2. Welds: All welds shall be ground smooth, paint all seams. CLIENT / PROJECT ENVIRONMENTS & EXPERIENCES CIty of Greenville, NC 120 North Church Street City of Greenville, NC merje Suite 208 Wayfinding and Signage West Chester, PA 19380 T 484.266.0648 www.merjedesign.com PROJECT NO. Y41-07963 SUBCONSULTANT SHEET TITLE DRAWN BY: KΒ 6/30/2009 Sign Type PARK.10-11 REVISIONS These drawings are meant for DESIGN INTENT ONLY Parking Identification and are not for construction. Contractor shall verify and be responsible for all dimensions and conditio 5/22/2010 of the job. Contractor shall be familiar with the site


E.2


and conditions it presents. This office must be notified of any variations from the dimensions and cond tions shown on this drawing. Shop drawings and details must be submitted to this office for approval

prior to proceeding with fabrication. All copy shall be proofread by client and legal requirements checked

by legal department.

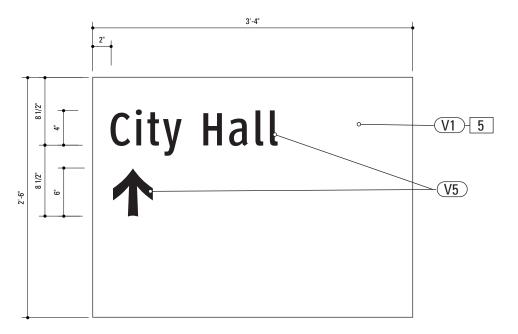

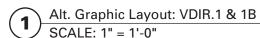

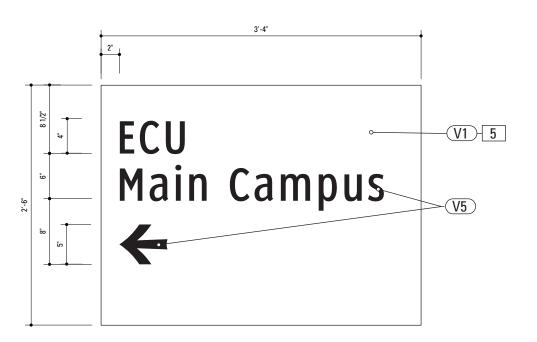

Alt. Graphic Layout: VDIR.1 & 1B
SCALE: 1" = 1'-0"

SPECIFICATIONS SIGN TYPE: VDIR.1-1B FUNCTION: Vehicular Directional

5. SIGN PANEL

MATERIAL: 1/4" thk Aluminum FABRICATION PROCESS: Square Cut EDGES: Square COLOR: custom, as noted SURFACE PROCESS: Paint all exposed surfaces CLEARCOAT: Acrylic Polyurethane Clear Satin FASTENER: Mechanically fastened to backer panel


Reflective Vinyl Graphics applied to front face of Sign Panel.

See Color Page for Specifications.

Final design and shop drawings shall be supplied by the fabricator. North Carolina registered professional engineer is required to sign and seal the submittal of shop drawings.

- 1. Fabricator shall verify the mounting conditions and provide a detail drawing for each mounting situation, prior to fabrication. Fabricator shall obtain approval from the Designer or Client for placement prior to fabri-
- 2. Welds: All welds shall be ground smooth, paint all seams.

ENVIRONMENTS &	EXPERIENCES	CLIENT / PROJECT	
merje	120 North Church Street Suite 208 West Chester, PA 19380 T 484.266.0648	Clty of Greenville, NC City of Greenville, NC Wayfinding and Signage	
	www.merjedesign.com	PROJECT NO. Y41-07963	
JBCONSULTANT		SHEET TITLE	
6/30/2009	DRAWN BY: KB	Sign Type VDIR.1-1B	
ese drawings are meant for DESIGN INTENT ONLY d are not for construction. Contractor shall verify	REVISIONS	Vehicular Directional	
d be responsible for all dimensions and conditions the job. Contractor shall be familiar with the site d conditions it presents. This office must be noti-	5/22/2010		
d of any variations from the dimensions and condi- ns shown on this drawing. Shop drawings and		SHEET NO.	
ails must be submitted to this office for approval or to proceeding with fabrication. All copy shall be ofread by client and legal requirements checked legal department.		E.3	

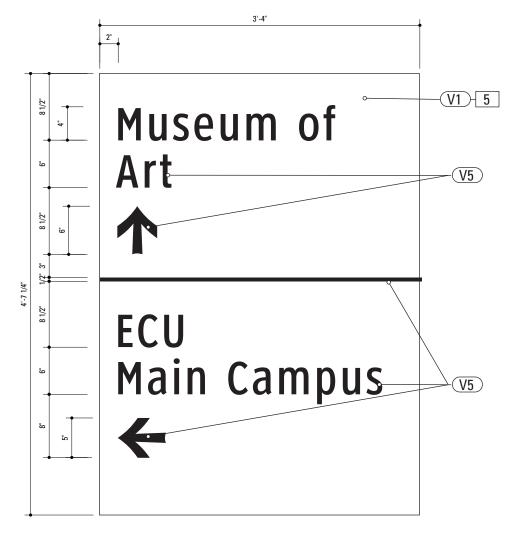

County Admin. VI 5
Office

Town
Common
V5

Alt. Graphic Layout: VDIR.2 & 2B

SCALE: 1" = 1'-0"

Alt. Graphic Layout: VDIR.2 & 2B SCALE: 1" = 1'-0"

SPECIFICATIONS SIGN TYPE: VDIR.2-2B FUNCTION: Vehicular Directional

5. SIGN PANEL

MATERIAL: 1/4" thk Aluminum
FABRICATION PROCESS: Square Cut
EDGES: Square
COLOR: custom, as noted
SURFACE PROCESS: Paint all exposed surfaces
CLEARCOAT: Acrylic Polyurethane Clear Satin
FASTENER: Mechanically fastened to backer panel

Reflective Vinyl Graphics applied to front face of Sign Panel. See Color Page for Specifications.

DESIGN NOTE:


Final design and shop drawings shall be supplied by the fabricator. North Carolina registered professional engineer is required to sign and seal the submittal of shop drawings.


NOTES

by legal department.

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- 2. Welds: All welds shall be ground smooth, paint all seams.

CLIENT / PROJECT ENVIRONMENTS & EXPERIENCES CIty of Greenville, NC 120 North Church Street City of Greenville, NC Suite 208 Wayfinding and Signage West Chester, PA 19380 T 484.266.0648 www.merjedesign.com PROJECT NO. Y41-07963 SUBCONSULTANT KB 6/30/2009 Sign Type VDIR.2-2B These drawings are meant for DESIGN INTENT ONLY Vehicular Directional and are not for construction. Contractor shall verify and be responsible for all dimensions and condition 5/22/2010 of the job. Contractor shall be familiar with the site and conditions it presents. This office must be notified of any variations from the dimensions and cond tions shown on this drawing. Shop drawings and details must be submitted to this office for approval **E.4** prior to proceeding with fabrication. All copy shall be proofread by client and legal requirements checked

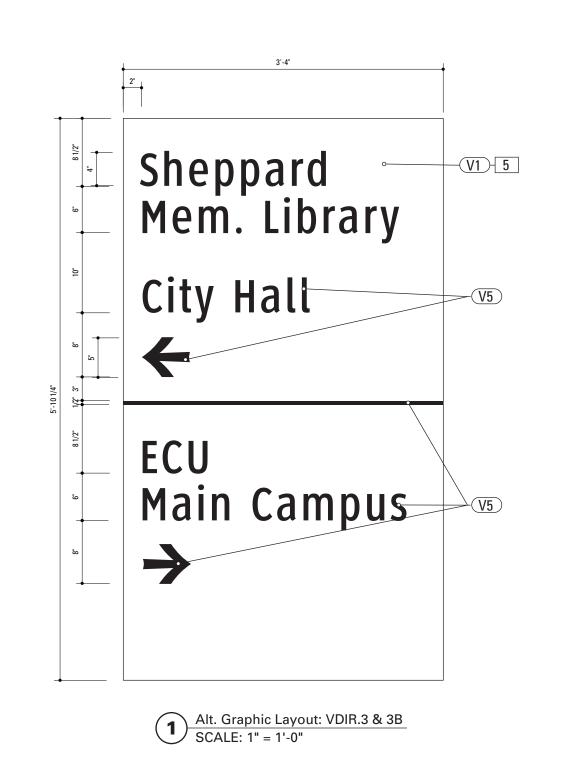

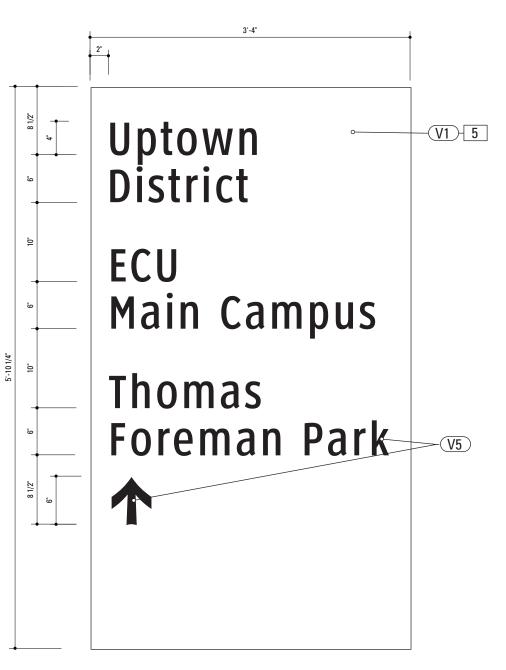

Alt. Graphic Layout: VDIR.3 & 3B SCALE: 1" = 1'-0"

SPECIFICATIONS SIGN TYPE: VDIR.3-3B FUNCTION: Vehicular Directional

5. SIGN PANEL

MATERIAL: 1/4" thk Aluminum FABRICATION PROCESS: Square Cut EDGES: Square COLOR: custom, as noted SURFACE PROCESS: Paint all exposed surfaces CLEARCOAT: Acrylic Polyurethane Clear Satin FASTENER: Mechanically fastened to backer panel

Reflective Vinyl Graphics applied to front face of Sign Panel. See Color Page for Specifications.

CLIENT / PROJECT


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- 2. Welds: All welds shall be ground smooth, paint all seams.

proofread by client and legal requirements checked

by legal department.

ENVIRONMENTS & EXPERIENCES Clty of Greenville, NC 120 North Church Street City of Greenville, NC merje Suite 208 Wayfinding and Signage West Chester, PA 19380 T 484.266.0648 www.merjedesign.com PROJECT NO. Y41-07963 SUBCONSULTANT ΚB 6/30/2009 Sign Type VDIR.3-3B REVISIONS These drawings are meant for DESIGN INTENT ONLY Vehicular Directional and are not for construction. Contractor shall verify and be responsible for all dimensions and conditio of the job. Contractor shall be familiar with the site 5/22/2010 and conditions it presents. This office must be notified of any variations from the dimensions and cond tions shown on this drawing. Shop drawings and details must be submitted to this office for approval E.5 prior to proceeding with fabrication, All copy shall be

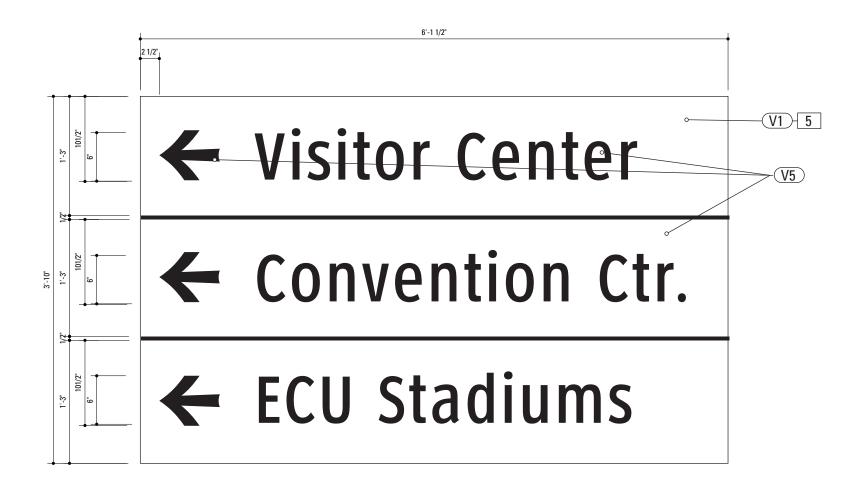

Alt. Graphic Layout: VDIR.4

SCALE: 1" = 1'-0"


SPECIFICATIONS SIGN TYPE: VDIR.4 FUNCTION: Vehicular Directional 5. SIGN PANEL MATERIAL: 1/4" thk Aluminum FABRICATION PROCESS: Square Cut EDGES: Square COLOR: custom, as noted SURFACE PROCESS: Paint all exposed surfaces CLEARCOAT: Acrylic Polyurethane Clear Satin FASTENER: Mechanically fastened to backer panel Reflective Vinyl Graphics applied to front face of Sign Panel. See Color Page for Specifications. Final design and shop drawings shall be supplied by the fabricator. North Carolina registered professional engineer is required to sign and seal the submittal of shop drawings.


NOTE


- Fabricator shall verify the mounting conditions and provide a detail drawing for each mounting situation, prior to fabrication. Fabricator shall obtain approval from the Designer or Client for placement prior to fabrication.
- 2. Welds: All welds shall be ground smooth, paint all seams.

CLIENT / PROJECT ENVIRONMENTS & EXPERIENCES CIty of Greenville, NC 120 North Church Street City of Greenville, NC Suite 208 Wayfinding and Signage West Chester, PA 19380 T 484.266.0648 www.merjedesign.com PROJECT NO. Y41-07963 SUBCONSULTANT SHEET TITLE DRAWN BY: ΚB 6/30/2009 Sign Type VDIR.4 REVISIONS These drawings are meant for DESIGN INTENT ONLY Vehicular Directional and are not for construction. Contractor shall verify and be responsible for all dimensions and condition of the job. Contractor shall be familiar with the site 5/22/2010 and conditions it presents. This office must be notified of any variations from the dimensions and cond tions shown on this drawing. Shop drawings and details must be submitted to this office for approval **E.6** prior to proceeding with fabrication. All copy shall be proofread by client and legal requirements checked by legal department.

F. Construction Details

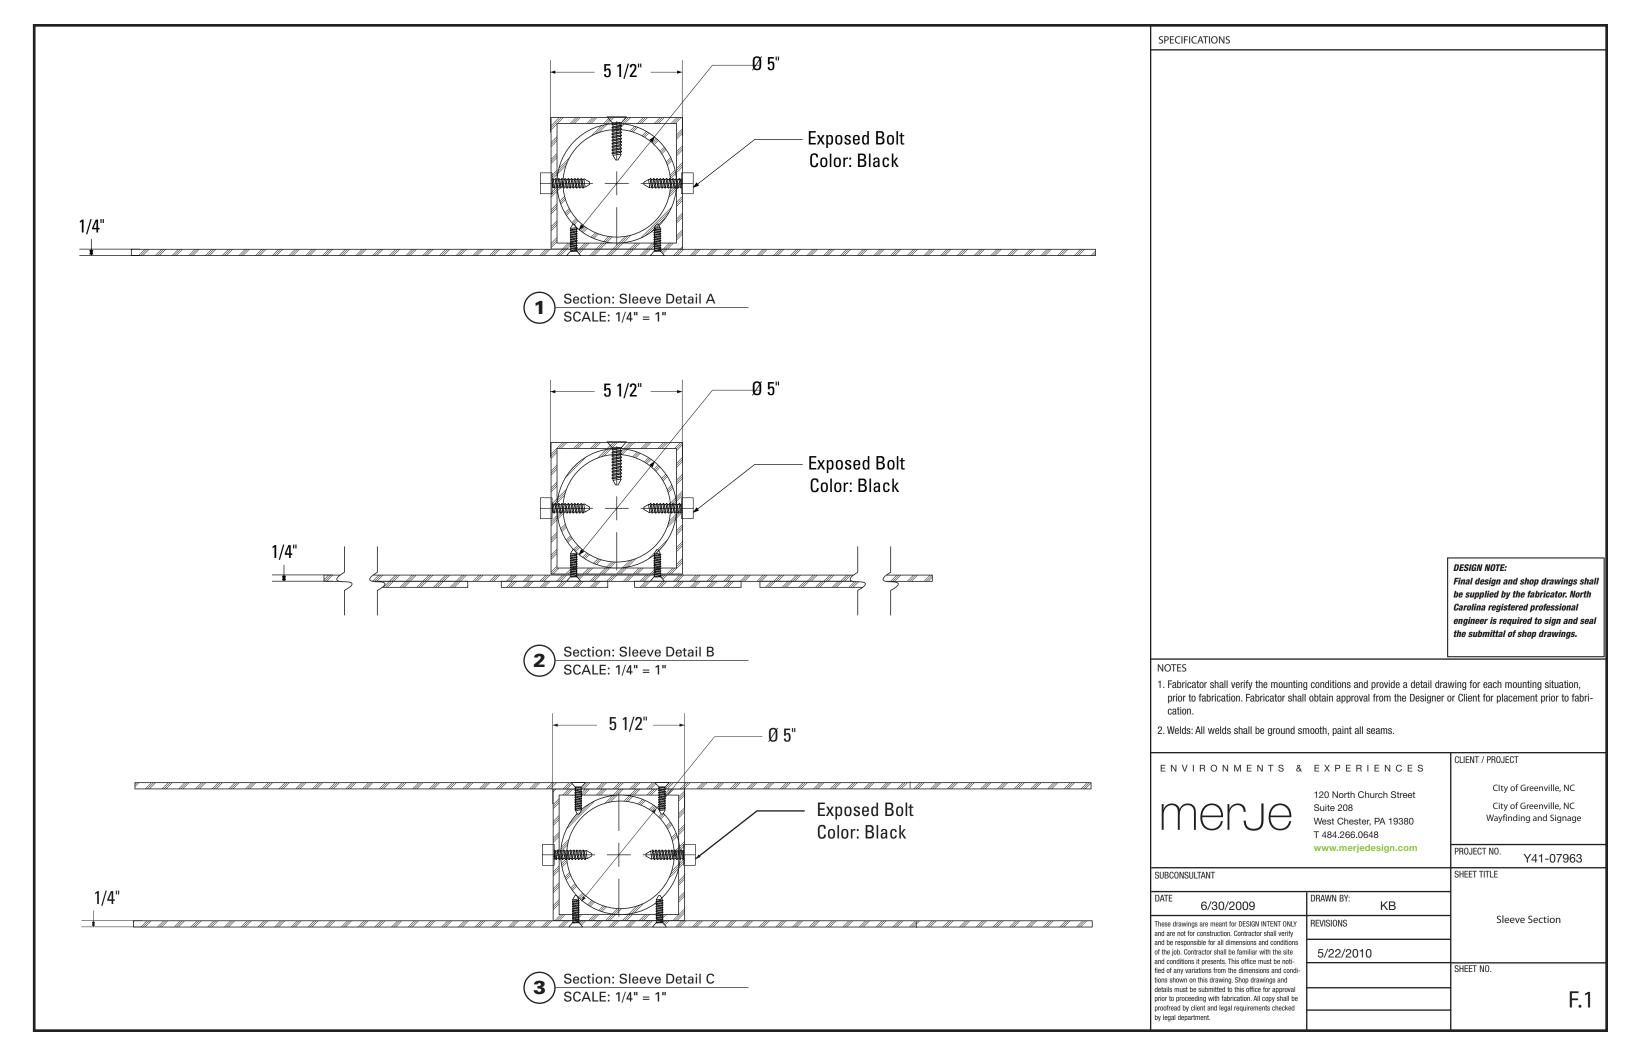


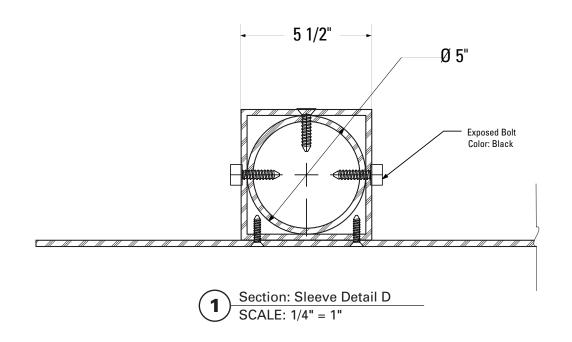

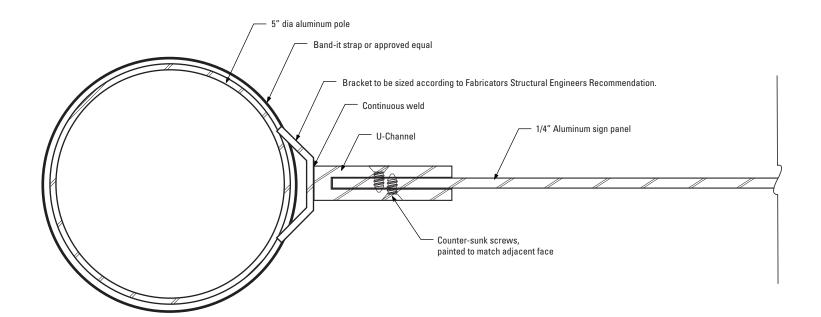


Section: PED.1-2 SCALE: 1/2" = 1"

SPECIFICATIONS DESIGN NOTE: Final design and shop drawings shall be supplied by the fabricator. North Carolina registered professional engineer is required to sign and seal the submittal of shop drawings. 1. Fabricator shall verify the mounting conditions and provide a detail drawing for each mounting situation, prior to fabrication. Fabricator shall obtain approval from the Designer or Client for placement prior to fabri-2. Welds: All welds shall be ground smooth, paint all seams. CLIENT / PROJECT ENVIRONMENTS & EXPERIENCES Clty of Greenville, NC 120 North Church Street City of Greenville, NC Suite 208 Wayfinding and Signage West Chester, PA 19380 T 484.266.0648 www.merjedesign.com PROJECT NO. Y41-07963 SHEET TITLE SUBCONSULTANT DRAWN BY: 6/30/2009 KΒ Sleeve and Bracket These drawings are meant for DESIGN INTENT ONLY and are not for construction. Contractor shall verify REVISIONS Sections and be responsible for all dimensions and conditions of the job. Contractor shall be familiar with the site 5/22/2010 and conditions it presents. This office must be noti-SHEET NO. fied of any variations from the dimensions and condi tions shown on this drawing. Shop drawings and details must be submitted to this office for approval F.2 prior to proceeding with fabrication. All copy shall be proofread by client and legal requirements checked by legal department.

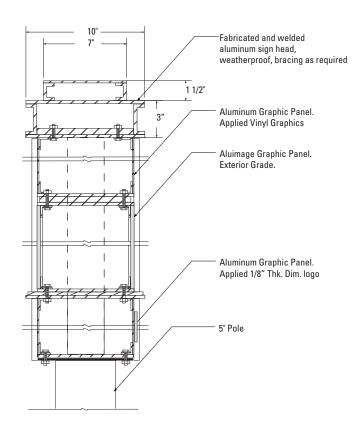

Section: KIOSK.1 SCALE: 1 1/2" = 1'-0"

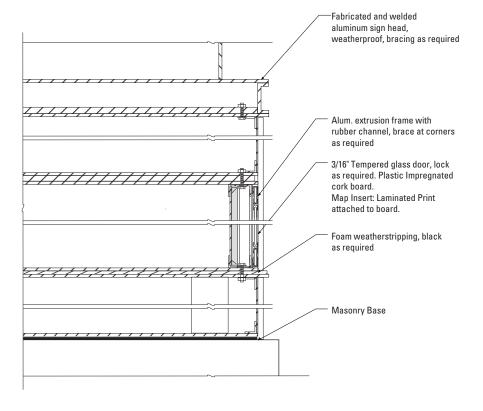


Section: KIOSK.2 SCALE: 1/4" = 1"

DESIGN NOTE: Final design and shop drawings shall be supplied by the fabricator. North Carolina registered professional engineer is required to sign and seal the submittal of shop drawings. 1. Fabricator shall verify the mounting conditions and provide a detail drawing for each mounting situation, prior to fabrication. Fabricator shall obtain approval from the Designer or Client for placement prior to fabri-2. Welds: All welds shall be ground smooth, paint all seams. CLIENT / PROJECT CIty of Greenville, NC 120 North Church Street City of Greenville, NC Suite 208 Wayfinding and Signage West Chester, PA 19380

SPECIFICATIONS

ENVIRONMENTS & EXPERIENCES T 484.266.0648 www.merjedesign.com PROJECT NO. Y41-07963 SHEET TITLE SUBCONSULTANT DRAWN BY: 6/30/2009 KΒ **Kiosk Sections** REVISIONS These drawings are meant for DESIGN INTENT ONLY and are not for construction. Contractor shall verify and be responsible for all dimensions and condition of the job. Contractor shall be familiar with the site 5/22/2010 and conditions it presents. This office must be noti-SHEET NO. fied of any variations from the dimensions and cond tions shown on this drawing. Shop drawings and details must be submitted to this office for approval F.3 prior to proceeding with fabrication. All copy shall be proofread by client and legal requirements checked by legal department.

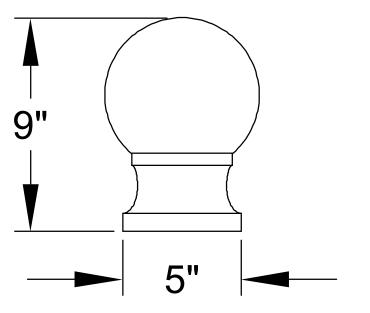

SPECIFICATIONS

CONSTRUCTION

The finials shall be one-piece construction. The finials shall consist of a one-piece casting or a casting welded to a piece of aluminum tubing. All welding shall be per ANSI/AWS D1.2-90. All welders shall be certified per ANSI/AWS D1.2-90 Section 5.

MATERIALS

The finial castings shall be shall be heavy wall, cast aluminum produced from certified ASTM 356.1 ingot per ASTM B-179-95a or ASTM B26-95. The tubing shall be aluminum, ASTM 6061 alloy, heat treated to a T6 temper. All hardware shall be stainless steel.


INSTALLATION

The finials shall mount to a 3" O.D. x 3" tall tenon using stainless steel socket set screws.

SPECIFICATIONS	SIGN TYPE:	as specified	FUNCTION:
Pole Cap Finial			
·			
			DESIGN NOTE:
			Final design and shop drawings shall
			be supplied by the Contractor. North Carolina registered professional
			engineer is required to sign and seal
			the submittal of shop drawings.
NOTES			
			l drawing for each mounting situation, prior r Client for placement prior to fabrication.
2. Welds: All welds shall be ground	nd smooth, paint	t all seams.	

3. Hardware: All exposed hardware shall be tamper proof fasteners.

ENVIRONMENTS &	EXPERIENCES	CLIENT / PROJECT
merje	120 North Church Street Suite 208 West Chester, PA 19380 T 484.266.0648	Clty of Greenville, NC City of Greenville, NC Wayfinding and Signage
	www.merjedesign.com	PROJECT NO. Y41-07963
SUBCONSULTANT		SHEET TITLE
DATE 6/30/2009	DRAWN BY: KB	
These drawings are meant for DESIGN INTENT ONLY and are not for construction. Contractor shall verify	REVISIONS	Decorative Post Cap
and be responsible for all dimensions and conditions of the job. Contractor shall be familiar with the site and conditions it presents. This office must be noti-	5/22/2010	
fied of any variations from the dimensions and conditions shown on this drawing. Shop drawings and		SHEET NO.
details must be submitted to this office for approval prior to proceeding with fabrication. All copy shall be proofread by client and legal requirements checked by legal department.		F.4
1 , , , , , , , , , , , , , , , , , , ,	ſ	1

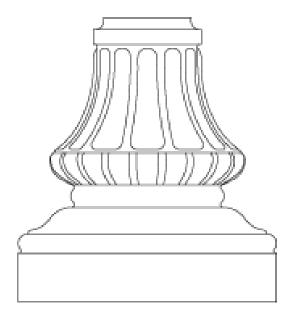

Specifications

HOUSING:

356 HM high-strength, low-copper, proprietary cast aluminum alloy .

Thermoset polyester powdercoat is electrostatically applied after a five-stage conversion cleaning process and bonded by heat fusion thermosetting. Laboratory tested for superior weatherability and fade resistance in accordance with ASTM B-117-64 and ANSI/ASTM G53-77 specifications. For larger projects where a custom color is required, contact the factory for more information.

CERTIFICATIONS:

Manufactured to ISO 9001:2000 Standards.

WARRANTY:

Three-year limited warranty.

Height:

Base Diameter:

Inside Diameter:

16 1/2"

SPECIFICATIONS SIG	GN TYPE:	as specified	FUNCTION:	
			be supplied by Carolina regist engineer is req	nd shop drawings shall the Contractor. North ered professional wired to sign and seal of shop drawings.
NOTES				
Contractor to verify the mounting of the fabrication. Contractor must obtain the fabrication for the				
2. Welds: All welds shall be ground si	mooth, paint a	all seams.		
3. Hardware: All exposed hardware sl	hall be tampe	r proof fasteners		
ENVIRONMENTS &	EXPE	RIENCES	CLIENT / PROJEC	CT
merje	Suite 208 West Ches T 484.266.		City	of Greenville, NC of Greenville, NC Iding and Signage
	www.mer	jedesign.com	PROJECT NO.	Y41-07963
SUBCONSULTANT			SHEET TITLE	
DATE 6/30/2009	DRAWN BY:	KB	Decorati	ve Wrap Around
These drawings are meant for DESIGN INTENT ONLY and are not for construction. Contractor shall verify and be recognished for all dimensions and conditions	REVISIONS			Base
and be responsible for all dimensions and conditions of the job. Contractor shall be familiar with the site and conditions it presents. This office must be noti-	5/22/20	10		
fied of any variations from the dimensions and condi- tions shown on this drawing. Shop drawings and details must be submitted to this office for approval			SHEET NO.	

F.5


SIGN TYPE: as specified FUNCTION:


SPECIFICATIONS


prior to proceeding with fabrication. All copy shall be proofread by client and legal requirements checked

by legal department.

G. Footers

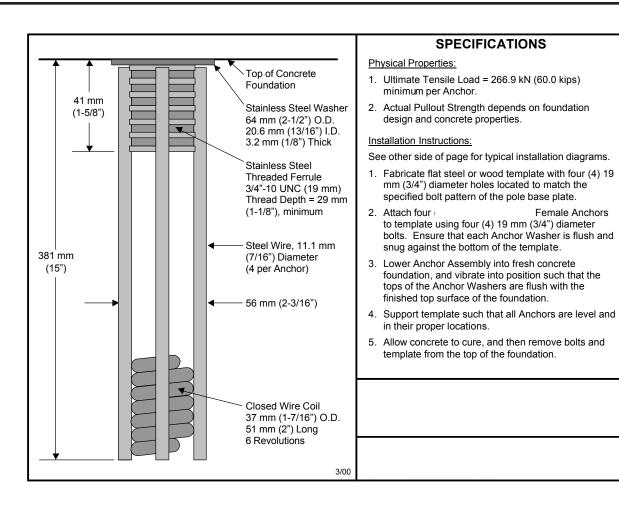

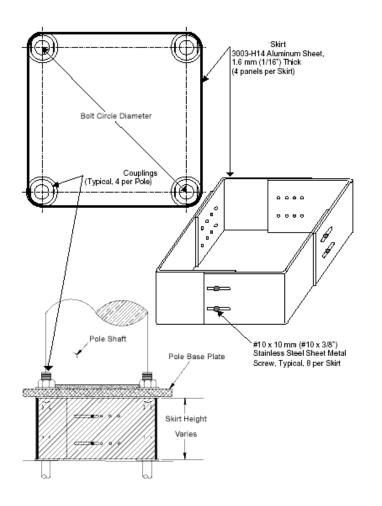

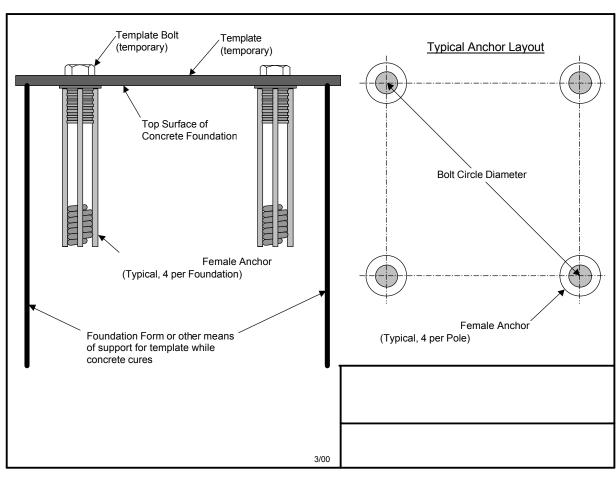

SPECIFICATIONS

PERFORMANCE CRITERIA:

- Double-Neck Pole-Safe meets all requirements of "AASHTO Standard Specifications for Structural Supports for Highway Signs, Luminaries, and Traffic Signals."
- 2. Double-Neck Pole-Safe has been crash-tested and FHWA approved in accordance with the requirements of NCHRP Report 350, "Recommended Procedures for the Safety Performance Evaluation of Highway Features."
- 3. Maximum Allowable Pole Mass = 450 kg (922 lb) (total including fixtures).

PHYSICAL PROPERTIES PER COUPLING:

- 1. Ultimate Tensile Strength = 221.5 kN (49.8 kips), minimum
- 2. Tensile Yield Strength = 192.0 kN (43.2 kips), minimum.
- 3. Ultimate Restrained Shear Strength = 24.5 kN (5.5 kips), maximum

CORROSION PROTECTION:


All Hardware items are American Standard sizes, galvanized in accordance with ASTM A153 (hot dipped).

DESIGN NOTE:

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- 3. Hardware: All exposed hardware shall be tamper proof fasteners.

ENVIRONMENTS &	EXPERIENCES	CLIENT / PROJECT
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	www.merjedesign.com	PROJECT NO. Y41-07963
SUBCONSULTANT	SHEET TITLE	
OATE 6/30/2009	DRAWN BY: KB	Breakaway Footer
hese drawings are meant for DESIGN INTENT ONLY nd are not for construction. Contractor shall verify	REVISIONS	Details
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etails must be submitted to this office for approval rior to proceeding with fabrication. All copy shall be roofread by client and legal requirements checked y legal department.		G.1

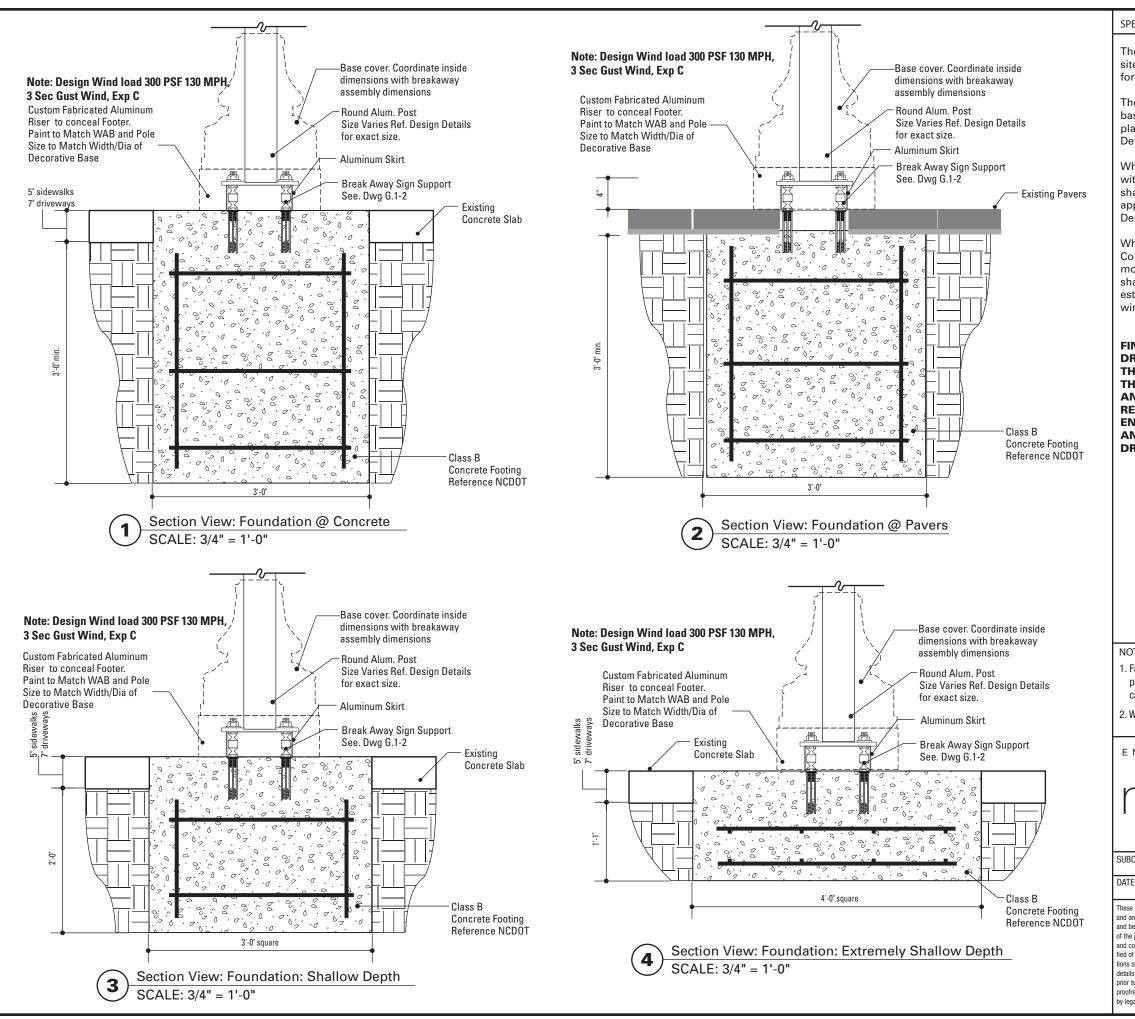

SPECIFICATIONS

The Contractor shall be familiar with all site conditions and shall be responsible for all underground utility checks.

The Contractor shall be familiar with all basement/vault locations by obtaining plans from the City of Greenville Department of Public Works.

Where a basement/vault interferes with a proposed location. The sign shall be relocated to a location deemed appropriate by the City of Greenville Department of Public Works

Where relocation is not an option the Contractor will develop the appropriate mounting solution. The solution shall meet all engineering criteria as established by the standard footings. (i.e. windloads)

FINAL DESIGNS AND SHOP DRAWINGS SHALL BE SUPPLIED BY THE CONTRACTOR FOR EACH OF THE BREAK-AWAY POLES IDENTIFIED AND A NORTH CAROLINA REGISTERED PROFESSIONAL ENGINEER IS REQUIRED TO SIGN AND SEAL THE SUBMITTAL OF SHOP DRAWINGS.

NOTE:


- 1) SOIL IS AVERAGE WITH MAXIMUM ALLOWABLE SOIL PRESSURE OF 3,000 POUNDS PER SQUARE FOOT. SOIL UNIT WEIGHT OF 125 PCF AND FRICTION ANGLE OF 30 DEGREES (ASSUMED).
- 2) CONCRETE STRENGTH AT 28 DAYS F'C=4,000 PSI REINFORCEMENT SHALL BE ASTM 36 FY=60,000 PSI
- 3) FOLLOW 2008 NCDOT DESIGN STANDARDS FOR MATERIAL AND CONSTRUCTION INFORMATION FOR THE SIGN POST BASES AND FOUNDATIONS NOT OTHERWISE SPECIFIED IN THESE CONTRACT DRAWINGS
- 4) FOR SIGN POST SIZES REFER TO THE DESIGN INTENT DRAWING SHEETS, CONTRACTOR TO VERIFY APPROPRIATE STRUCTURAL POST SIZE REQUIREMENTS.

DESIGN NOTE:


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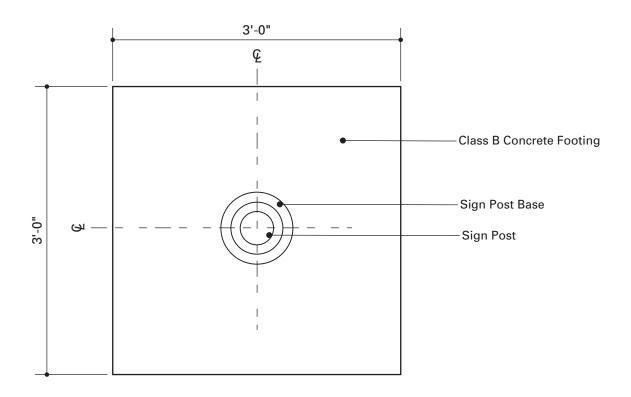
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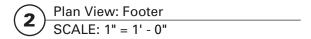




NOTE: When locating a footer within a single pavement block (max. 5'-0" x 5'-0"), adjacent to at least 2 expansion joints, the entire block of pavement shall be removed and replaced with the same materials and finish of adjacent sidewalk areas.

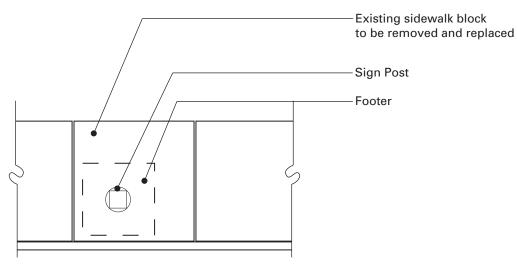



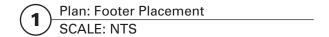

SPECIFICATIONS

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DRAWINGS SHALL BE SUPPLIED BY
THE CONTRACTOR FOR EACH OF
THE BREAK-AWAY POLES IDENTIFIED
AND A NORTH CAROLINA
REGISTERED PROFESSIONAL
ENGINEER IS REQUIRED TO SIGN
AND SEAL THE SUBMITTAL OF SHOP
DRAWINGS.

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	www.merjedesign.com	PROJECT NO. Y41-07963	
SUBCONSULTANT		SHEET TITLE	
6/30/2009	DRAWN BY: KB	Breakaway Footer	
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prior to proceeding with fabrication. All copy shall be proofread by client and legal requirements checked by legal department.		G.3	

SECTION 2 | Programming

G. Message Schedule

I. Removal Plan